

Main Office

Golayee Wazirabad PO Box 208

REQUEST FOR QUOTATION

Construction of Check Dam for DACAAR Program UNODC Project Kabul, Afghanistan Phone: +93 202230752 in Khwaja Jamal Village Nawzad District of Helmand Province +٩٣٢٠٢٢٣٠٧۵٢. Mobile: +93 700288232

موبایل: ۹۳۷۰۰۲۸۸۲۳۲+

E-mail: dacaar@dacaar.org Website: www.dacaar.org

درخواست آفر برای اعمار و ساخت چک دم برای پروگرام داکار پروژه UNODC در قریه خواجه جمال ولسوالی نوزاد ولایت هلمند

ايميل: dacaar@dacaar.org وبسایت: www.dacaar.org

Date: May 12, 2025

DACAAR RFQ 31 PRF-314/UNODC/2407-UNODC/UHLA1.1.1/05.2025

DACAAR needs Construction of Check Dam in Khwaja Jamal Village Nawzad District of Helmand Province and invites interested parties to submit their sealed offers for the required job mentioned in Annex (I).

داکار برای اعمار و ساختمان یک چک دم که در ضمیمه (۱) از آن به تفصیل ذکر گر دیده در قریه خواجه جمال ولسوالی نوزاد ولايت هلمند ضرورت دارد، و از تمام علاقمندان واجد شرايط تقاضا بعمل میآور د تا آفر های سر بسته شانر ا قبل از معیاد تعین شده به دفتر داکار بسیارند.

The offers must be submitted to DACAAR Main Office Logistics Unit located in Street No. 12, Taimani Project, Qala-e-Fathullah, Kabul Province till 4:00 PM May 23, 2025.

آفرها بايد الى تاريخ 23 مى 2025 ساعت 4:00 عصر به شعبه لوجستیک دفتر مرکزی داکار واقع پروژه تایمنی پایکوب نصوار سرک 12 قلعه فتح الله ولايت كابل سيرده شود.

The offers will be opened on May 25, 2025 at 10:00am in DACAAR Main Office, Kabul Province and the winner of the biding will be notified shortly after the bid opening session.

مجلس آفر گشاہی ساعت 10:00 قبل از ظهر 25 می 2025 در دفتر مرکزی داکار در و لایت کابل صورت میگیر د که متعاقباً برنده داوطلبی در اسرع وقت اطلاع خواهد یافت.

Please use Annex (III) for Technical Specification, Annex (II) for Work Plan and Annex (I) for Financial purposes.

لطفاً ضميمه (I) را بخاطر ارايه آفر، ضميمه (II) را بخاطر بلان کاری و ضمیمه (III) را بخاطر مشخصات تخنیکی مشاهده نمائید.

Terms and Conditions for Participation/Bid Winner

1. Contractor should Construct the Check Dam in Khwaja Jamal Village Nawzad District of Helmand Province based on completion plan mentioned in Annex (II).

شرایط قرارداد برای برنده داوطلبی/ اشتراک کننده گان

- 1. قرار داد گیرنده مکلف است تا اعمار چک دم را که در قریه خواجه جمال ولسوالي نوزاد ولايت هلمند موقعيت دارد، طبق بلان کاری که در ضمیمه (II) ذکر گر دیده تکمیل نماید.
- 2. Priority is given to construction companies.
- 2. حق او لویت به شرکت های ساختمانی داده میشود.
- 3. Similar works experience as prime contractor in the construction of at least one works in nature and complexity equivalent.
- 3. داشتن تجربه کاری مشابه حداقل یک بروژه که ماهیت و پیچیدگی آن مشابه به این پروژه باشد.
- 4. Provision of all tools and equipment's required for the Construction of Check Dam belongs to the contractor.
- 4. تهیه تمام وسایل و مواد برای اعمار و ساختمان چک دم معه اعاشه و اباطه بدوش قرارداد گیرنده میباشد.
- 5. Payment will be made within 15 working days after and successfully technical team confirmation completion of the contract.
- 5. يرداخت يول بعد از تصديق بخش تخنيكي داكار و تكميل نمودن مؤفقانه قرارداد در مدت 15 روز کاری اجرا میگردد.

- 6. The bid winner must deposit 10% amount of total contract value to DACAAR bank account as a Contract Performance Guarantee before signing the contract, the mentioned amount only refundable after successful completion of the contract.
- 7. In case of delay in contract completion without any logical reasons, 0.5% of total value of the remaining work will be deducted from the payment. This penalty will charge per each official day of delay.
- 8. Quotations should be valid for 60 official days.
- Prices shall be given in Afghanis (AFN) and must include all duties, transport cost, loading and unloading costs. Offers without sign and stamp will not be accepted. Manipulated/overwritten offers will automatically be rejected.
- 10. DACAAR's technical team (Site Engineer) will check quality of work. If it is not according to the specifications, DACAAR Technical Team has reserved the right to terminate the contract without any compensation paid to the contractor.
- 11. 2% Tax will be applicable on the companies that has valid business license and 7% Tax will be applicable on the companies that have invalid business license, or on individuals who do not have business license, will be deducted from the contractor as a withholding tax and DACAAR will pay that amount to Ministry of Finance, the amount starts from (1 AFN).
- 12. DACAAR does not accept sub-contract, in case if it is found that the contract has given to sub-contracting contractor, the contract will automatically be terminated and the supplier will lose their performance guarantee and no compensation will be paid to the contractor.
- 13. DACAAR will not be responsible for any changes occurred during the contract such as (increment in custom duties, exchange rate etc.)

- و. برنده داوطلبی مکلف است تا %10 مجموع ارزش قرارداد را بشکل تضمین بانکی از اجرای کامل و مؤفقانه قرارداد قبل از امضا آن به حساب بانکی داکار بپردازد. مبلغ متذکره در صورت اجرأ مؤفقانه قرارداد قابل باز پرداخت میباشد.
- در صورت تأخیر در تكمیل قرراداد بدون عذر موجه در وقت معینه آن، مبلغ %0.5 از هر روز كار تأخیر شده بطور جرمانه از مجموع ارزش قرارداد اخذ میگردد.
- قیمت داده شده باید برای مدت 60 روز کاری مدار اعتبار باشد.
- و. قیمت ها به افغانی داده شود و باید شامل مالیات، انتقال، قیمت بارگیری و تخلیه باشد و قیمت هائیکه بدون مهر و امضأ قابل قبول نمیباشد. آفرهای قلم خورده گی بطور اتومات رد میگردد.
- 10. هئیت تفتیش و بررسی داکار کیفیت کار را به اساس قرارداد چک و ملاحظه نموده در صورتیکه مطابق به مشخصات قرارداد نباشد، داکار حق دارد تا قرارداد را بدون جبران کدام خساره فسخ نماید.
- 11. %2 مالیه برای شرکت هائیکه دارای جواز با اعتبار میباشد، و %7 مالیه برای شرکت هائیکه معیاد جواز آن تکمیل گردیده باشد، و یا اشخاصیکه جواز ندارند توسط داکار وضع گریده و به وزارت مالیه پرداخت میشود، آغاز مبلغ از (1 افغانی).
- 12. داکار به هیچ عنوان قرارداد دست دو را نه پذیرفته، در صورت وقوع چنین حالت قرارداد بصورت اتومات فسخ و قرارداد گیرنده پول تضمین و حق اجوره خویش را از دست مدهد
- 13. داکار به هیچ عنوان مسؤولیت بلند رفتن مالیات گمرکی، اسعار خارجی وغیره مواردی که باعث بلند رفتن قیمت در جریان قرارداد گردد ندارد.

- 14. DACAAR (Logistics Unit) adheres to National and International laws on child labour DACAAR makes sure all its suppliers and vendor abide by such laws preventing child labour in all DACAAR activities countrywide.
- 15. The Humanitarian Organizations (HO) may conduct on- site visit in the contractor's premises (or may take similar measures) to ensure compliance.
- 16. DACAAR has a zero-tolerance policy on sexual exploitation, abuse and harassment, which is defined and described in the policy document "DACAAR policy on preventing and handling sexual exploitation, abuse and harassment".
- 17. Award of contract will be based on the price, capacity and potentiality of bidder which will be decided after evaluation of the company; it is the right of DACAAR to make the decision of awarding contract.

- 14. دفتر داکار (شعبه لوژیستیک) با درنظرداشت قوانین ملی و بین المللی برای جلوگیری از کار کودکان مصمم بوده و سعی میکند که تمام فعالیتهای تهیه کننده گان و مشتریان این اداره به این اصل پابند باشند.
- 15. سازمان های بشر دوستانه (HO) ممکن است تا از محلات و سایت ها به بخاطر اطمینان خاطر و تطبیق درست کار توسط قرار داد گیرنده بازدید بعمل آورده ویا ممکن است اقدامات مشابه را انجام دهد.
- 16. داکار دارای پالیسی عدم تحمل در مورد سؤ استفاده، بد رفتاری و آزار و اذیت جنسی میباشد و موقف داکار در همچون مسایل بطور تفصیلی در پالیسی مذکور تشریح شده است.
- 17. برنده شدن قرارداد نظر به قیمت، توانائی و ظرفیت کاری داوطلب بوده و بعد از بررسی کمپنی صورت خواهد گرفت. البته داکار تنها حق تصمیم گیری در این زمینه را دارا میباشد.

For more details, please visit DACAAR Logistics Unit Main Office Kabul, Sunday through Thursday, from 8:00am to 03:00 PM or contact on below Email Addresses: jamal@dacaar.org or wasimullah@dacaar.org

Yours Sincerely,

Manager – Logistics Unit

Date: May 12, 2025

ANNEX (I)

Budget Breakdown/ فورم ارايه آفر DACAAR RFQ 31 PRF-314/UNODC/2407-UNODC/UHLA1.1.1/05.2025

Construction of Check Dam for DACAAR Program UNODC Project in Khwaja Jamal Village Nawzad District of Helmand Province:

S.N	Item Name and Specification	Unit	Quantity	Unit Price (AFN) (Including 2% or 7% Government Tax, transportation cost)	Total Price (AFN) (Including 2% or 7% Government Tax, transportation cost)
1	Excavation normal and removal of excess materials up to 500M	M^3	766		
2	Stone Masonary Work 1:4	M^3	608		
3	PCC 1:1.5:3	M^3	17		
4	PCC 1:2:4	M^3	31		
5	Denese Filling with quality will grade	M^3	285		
6	Pointing 1:3	M^2	468		
7	Gravel in Foundation with 15cm thickness	M^3	44		
8	Installation of Water Proof Concrete 1:4	M	12		
9	Installation of One Marble Sign Board 70*120cm	No	1		
	Grand Total: AFN				

Bidder Name:	اسم آفر دهنده:
Address and Stamp:	آدرس و مهر کمپنی
Contact No:	نمبر موبائيلنمبر موبائيل
Email Address:	ايمل آدرسالمل آدرسالمل آدرس
Delivery Period:	ز مان تحویل دهی

ANNEX (II) Tentative Work Plan/ پلان کاری تخمینی DACAAR RFQ 31 PRF-314/UNODC/2407-UNODC/UHLA1.1.1/05.2025

Construction of Check Dam for DACAAR Program UNODC Project in Khwaja Jamal Village Nawzad District of Helmand Province:

S/No	Specifications	Unit	Quantity of Work	Start Date of the Contract	End Date of the Contract	
1	Excavation normal and removal of excess materials up to 500M	M^3	766			
2	Stone Masonary Work 1:4	M^3	608			
3	PCC 1:1.5:3	M^3	17			
4	PCC 1:2:4	M^3	31			
5	Denese Filling with quality will grade	M^3	285	Starts After DACAAR Contract Final Approval	August 30, 2025	
6	Pointing 1:3	M^2	468			
7	Gravel in Foundation with 15cm thickness	M^3	44			
8	Installation of Water Proof Concrete 1:4	M	12			
9	Installation of One Marble Sign Board 70*120cm	tion of One Marble Sign Board 70*120cm No 1				

ANNEX (III)

Technical Specification/ مشخصات تخنيكى DACAAR RFQ 31 PRF-314/UNODC/2407-UNODC/UHLA1.1.1/05.2025

- 1- ټول ساختماني مواد باید داینجنیري نورم او معیار (ستنډرډ) مطابق وي او په ساحه کې هم په همدې مشخصاتو وساتل شي
- 2- د کار په دوران کې امنيتي او حفاظتي مسايل په جدي توګه مراعات کړل شي لکه د کاريګرانو خولي ، بوټ ،دستکش کمربند....
 - 3-بهرنی کارکونکی نشی کولای چی پرته د قانونی اسناد څخه پرته پدی پروژو کی کاروکړی
- 4- په هره پروژه کې باید دپروژي د اړند فعالیتونو دثبت او ریکار ډ په موخه ژورنال په ساحه کې موجودوي او دپروژي په پای کې ډاکار دفترته وسپارل شي
- 5- قرار دادکونکی شرکت مکلف دی چی د هری میاشتی په پای کی د پروژی د پرمختګ راپور ترتیب او ډاکار دفتر ته وسپاری چی ترڅو په ګوته شی چی کار دپلان مطابق دی او که خیر؟ ترڅو پروژه پخپل وخت او زمان تکمیل شی
 - 6- ساده کانکریت (PCC) باید د 150Kg/cm² باید فشاری مقاومت ولری
 - 7- سنگ کاری مصاله باید 1:4 وی او په ساحه کی باید معیاری منک موجودوی
 - 8- دهنگاف مصاله باید 1:3 وی
- 9- هغه ډېره (تیږه) چې په سنګ کاري کې په کاراچول کیږي باید پارچه او ماته شوی وی مخ ولري مقاومت ولري د کار په جریان کې باید د تیږو بافت په نظرکې ونیول شي ورته ډول ریګ او جغل باید د عضوی موادو خاوري او ګرد څخه پاک وي
- 10- سمنت باید تازه وی او په ساحه کی د اینجنیری نورم او ستنډرډ مطابق وساتل په یو ستون کی باید 5 بوجی څخه زیات سر په سرسټاک نشی
 - 11- دمصالی جوړول باید په مکسر ماشین ترسره شی
- 12- هغه اوبه چې په ساختماني چاروکې استعماليږي بايد پاکې وي او کفيت له نظره د تايد وړوي مالګينې نه وي قلويت او تيزابيت يې د منلو وړ حد کې وي
 - 13- سنګ کاری او ټول سیمنټی فعالیتونو او کارونولپاره د کاردمقاومت او کلکوالی په هدف دوامداره هره ورځ اوبه ورکول شی لږتر لږه دورځی 5 ځلی د 15 ورځو لپاره
 - 14- د كار په ساحه كي يواځي د پروژي پرسونل بايد وليدل شي او دغيرمسولو كسانوڅخه جدا مخنيوي وشي
 - 15- د پروژی د پرسونلو او کاری وسایلو ساتنه د شرکت مسولیت دی ډاکاریی هیڅ نوع مسولیت ناری
 - 16-شرکت باید د خپل شرکت فکت شیت او دساحوی اینجنیر CV د داوطلبی د فور مو سره یو کهای کړی
- 17- شرکت باید د کاری پلان مطابق او ډکار دفتر د ساحوی انیجنیر د سپارښتنو او هدایت په رڼاکی د پروژی کارونه سرته ورسوی
- 18- د داوطلبی ټولو کمپنیانو او شرکتونو څخه جدا غوښتنه کوو چی ورکول شوی شرایط ښه مطالعه کړی ترڅوپه راتلونکی کی د عذر اوبهانه چانس نه وی او شکایت یی هم نه اوریدل کیږی
- 19- هیڅ شرکت او کمپنی نشو کولی چی دا پروژه بل چاته په قرارداد ورکړی که داسی یو حالت رامنیځ ته شی قرارداد فسخ کیږی او دترسره شوی کار هیڅ معاوضه نه ورکول کیږی
 - 20-کوم وسایل ، مواد او پروسونل چی پدی پروژه کی په کاروړل کیږی باید د کیفیت اوکاری تجربی په بنیاد وټاکل شی
 - 21- ددی پروژی ټول کارونه د احجامو مطابق باید ترسره شی ، کچیری احجام کم شی د قرار داد د قیمت مطابق به هزینه او قیمت وضع کیږی او هیڅ ډول اضافه کارونه نه اجرا کیږی باید د ورکول شویو احجامو مطابق پروژه تکمیل شی

22- شرکت او کمپنی نشی کولی چی په پروژه کی تغیر او تبدیل راولی ، دضرورت په صورت کی به دډاکار له ساحوی او زون دفترونو سره شریک کیږی د لزوم په صورت کی به دمرکزی دفتر دتاید څخه وروسته اجراکیږی

23- د پیسو تادیه دهری پروژی د 100% د تکمیل څخه وروسته چې په هره ولسوالي کې موقیعت لري اجرا کیږي

24-تادیه د پیسود ورکول شویو احجامو او په ګوته شویو فعالیتونو مطابق ترسره کیږی او هیڅ ډول اضافه لګښتونه نه منل کیږی

25- شرکت باید ساحوی انجنیر د کاری تجربی په اساس ساحی ته توظیف کړی او پروژه په تخنیکی ډول تکمیل کړل شی

26- دکار له ساحی څخه د کندنکاری شویو موادو مناسب ځای ته انتقالول

27- د چک ډيم دهر ډول داوبو د ليکج (Leakage) مخنيوی د شرکت دنده او مسوليت دی

28- پرانه (ډکون) back filling لپاره مواد د انجنیری دنورم او ستنډر د مطابق او او 90٪ باید متراکم شی (Compaction) اود انیجنیری نورم مطابق هره طبقه باید د 20 سانتی متر په ضخامت compact شی

29- د طبعی پیښو په صورت کی ډاکار هیڅ ډول مسولیت نلری او د شرکت دنده ده چی د ورکول شویو احجامو مطابق پروژه تکمیله کړی

30- دپروژی د کارپه جریان کی ډکار د پرسونلو هیڅ نوع بیمه او یانور مصارف په غاړه نلری دادشرکت مسولیت دی چی خپلوپرسونلو حفاظتی تدابیر جدا په نظرکی ونیسی

DACAAR - Program

Technical and Coordination Unit/Survey and DesignTeam Bill of Quantity (BoQ) For Construction of Khwaja jamal Check Dam

Province

Helmand

District: Village: Nawzad Khwaja jamal

Contract:

Supproject Name:	Knwaja jamai Check Dam
4 BOO D-4-11	

itle	No.	Item	Norm/	Ougatite	Heir	Unit cost	Total cos
		Nem	Factor	Quantity	Unit	Afs	Afs
A1	1	Excavation		766.00	m3	-	
	1.01	Unskilled labor on site	0.5	383.00	md	-	
	2	Stone Masonry M(1:4) work		608.00	m3	0	
L	2.01	Stone including transportation	1.1	668.80		-	
L	2.02	Sandy gravel including Transportation	0.378	229.82	m3	_	
12	2.03	Cement including transportation	114	69312.00	kg	-	
L	2.04	Water	57	34656.00			
L	2.05	Skilled labor on site	0.5	304.00		-	
	2.06	Unskilled labor on site	1	608.00		2	
L	5	Gravel including transportation		44.00	m3	-	
3	5.01	Gravel	1.1	48.40		_	
	5.02	Unskilled labor on site	0.5	22.00			
4	7	Pointing of stone work M(1:3)		468.00			
	7.01	Sand including Transportation	0.024	11.23		-	
	7.02	Cement M(1:3) including transportation	2	936.00		-	
	7.03	Water	1	468.00		-	
	7.04	Skilled labor on site	0.17	79.56		82	
	7.05	Unskilled labor on site	0.05	23.40			
5	8	Filling with soil/gravel and compaction		285.00			
	8.01	Unskilled labor on site	0.5	142.50		-	
	10	PCC M (1:1.5:3)		17.00			
	10.01	Sand Gravel including transportation	1.055	17.94			
<u> </u>	10.02	Cement including transportation	250	4250.00	0.00000		
Ľ	10.03	Water	200	3400.00 [-	
	10.04	Skilled labor on site	0.7	0.78		-	8
	10.05	Unskilled labor on site	3.6	3.90 г		-	(-
	11	PCC M (1:2:4)	1/2	31.00 г	m3	0	
	11.01	Sand Gravel including transportation	1.157	35.87 r			
, _	11.03	Cement including transportation	230	7130.00 k			
	11.04	Water	115	3565.00 li			
	11.05	Skilled labor on site	0.65	20.15 r		-	
	11.06	Unskilled labor on site	3.25	100.75 r		-	/
	8	Installation of Waterproof PCC concret		12.00 n		/	
	9	Moblization	1000	1.00 L	100	0	. 0

Prepared by:

Name: Position:

Sayed Zaki Sadat Survey & Design Engineer 100

Signature:

Review and Checked by:

Name:

Sayed Najib Jalal

Position:

Survey & Design Coordinator

Signature:

Authorized by:

Name:

Position:

Signature:

Eng.Ab.Wali Muslih

Manager Technical & Coordination Uni

Approved by:

Name:

Position:

Signature:

Éng.Shah Wali

Deputy Director/Head of Program

Program / Technical Unit 2025

DACAAR - Program Technical and Coordination Unit/Survey and DesignTeam Bill of Quantity (BOQ) for Construction of Khwaja jamal Check Dam

Province District: Village:

Helmand Nawzad Khwaja jamal Subproject Name:

Khwaja jamal Estimation Date: 24.04.2025

S/N	Description	QNT	11						Submitti	ng Date:	24.04.20	25			
	Mobilization: includes the price of all activities such as the transfer of personnel, tools, vehicles, field	CANT	Unit	1	2	3	4	5	6	7	8	9	10	11	1
1	restablishment office and other activities for the implementation of the project and demobilization.	1	LS									A DO THAT CANDESS OF THE			
2	"Excavating normal works: which means digging works that were done without hydraulic machines and removal of excess materials up to 500 meters or according to the instructions of the field engineer. For more clarification, refer to paragraph 2.02 of technical specifications	766	-m3												
J	Dense filling" refers to the filling of material with the quality of Will Grade, which can be verified from one area and its density is not less than 90% of Proctor Mody Fide ATM. If the compaction is done by machine, the thickness of the soil should not be increased from 20 cents, in the images of compacting the soil by manual machines, its thickness should not be increased from 10 cents.	285	m3												
-	Stone Masonry work M(1:4): Wall stonework with a compromise of 1:4, with all its positive features, the stone must be solid, clean and free of dust according to the plan and opinion of the supervising engineer of the area.	608	m3												
	15cm thick sea gravel in the lower part of the tahadab: preparing, pouring and compacting the gravel filter made of vale-graded materials, it is poured under the paving stones or gabions (first, the tahadab is tamped, then the sea gravel carpet, then the paving stones or gabion work should be started.) These materials are a combination of sea sand with sea gravel or crushed gravel, which is the combination of the same sand and well Graded gravel. Approval of materials and type of work should be approved by the field engineer.	44	m3												
,	PCC M(1:1.5:3):Concrete without spikes with 20 MPa brand preparation, pouring, compacting and watering of 20 brand concrete, including molding with positive things according to the plan, technical specifications and approval of the supervising engineer.	17	m3				241								
	PCC M(1:2:4):Concrete without spikes with 15 MPa mark: preparation, pouring, compacting and watering of concrete mark 15, including molding with positive things according to the plan, technical specifications and approval of the supervising engineer.	31	m3				- 100								
3	Pointing,M (1:3): Pointing work is done with a ratio of cement and sand of 1:3, which includes materials, workers, soil, watering, etc. be executed Previously, from the beginning of the work, the seams should be cleaned up to 3 cm, then the work should be started. At the end of the work on the stones, the excess material should be cleaned in its correct shape. For more clarification, refer to paragraph 4.05 of the technical specifications.	468	m2												
)	Installation of waterproof PCC concrete (1:4): with positive aspects under the supervision of the supervising engineer.	12	m									A		1	

Prepared by: Name:

Position: Signature:

Sayed Zaki Sadat Survey & Design Engineer

24,04,2025

Review and Checked by:

Name: Position: Signature:

Sayed Najib Jalal Survey & Design Coordinator

Authorized by:

Name: Position: Eng.Ab.Wali Muslih Manager Technical

Signature:

Approved by:

Name: Position: Eng. Shah Wali

Signature:

Deputy Director/Head of Program

DACAAR - Program

Technical and Coordination Unit/Survey and DesignTeam Bill of Quantity (BOQ)for Construction of Khwaja jamal Check Dam

Province: Helmand District: Nawzad

Subproject Name:Khwaja jamal Estimation Date: 24.04.2025

Village: Khwaja jamal

rillage.			Submitt	ing Date:	e: 24.04.2025					
No.	ltem	Activities %	Quantity	NASSWEED COMMENTS	Unit cost	Total cost		tribution		
1	Mobilization: includes the price of all activities such as the transfer of personnel, tools, vehicles, field establishment office and other activities for the implementation of the project and demobilization.	70	1	LS	Afs	Afs	CDC, Afs	DACAAR, A		
2	"Excavating normal works: which means digging works that were done without hydraulic machines and removal of excess materials up to 500 meters or according to the instructions of the field engineer. For more clarification, refer to paragraph 2.02 of technical specifications		766	M3						
3	Dense filling" refers to the filling of material with the quality of Will Grade, which can be verified from one area and its density is not less than 90% of Proctor Mody Fide ATM. If the compaction is done by machine, the thickness of the soil should not be increased from 20 cents, in the images of compacting the soil by manual machines, its thickness should not be increased from 10 cents.		285	M3						
4	Stone Masonry work M(1:4): Wall stonework with a compromise of 1:4, with all its positive features, the stone must be solid, clean and free of dust according to the plan and opinion of the supervising engineer of the area.		608	M3						
5	15cm thick sea gravel in the lower part of the tahadab: preparing, pouring and compacting the gravel filter made of vale-graded materials, it is poured under the paving stones or gabions (first, the tahadab is tamped, then the sea gravel carpet, then the paving stones or gabion work should be started.) These materials are a combination of sea sand with sea gravel or crushed gravel, which is the combination of the same sand and well Graded gravel. Approval of materials and type of work should be approved by the field engineer.		44	МЗ						
U	PCC M(1:1.5:3):Concrete without spikes with 20 MPa brand preparation, pouring, compacting and watering of 20 brand concrete, including molding with positive things according to the plan, technical specifications and approval of the supervising engineer.		17	M3						
	PCC M(1:2:4):Concrete without spikes with 15 MPa mark: preparation, pouring, compacting and watering of concrete mark 15, including molding with positive things according to the plan, technical specifications and approval of the supervising engineer.		31	M3						
8	Pointing,M (1:3): Pointing work is done with a ratio of cement and sand of 1:3, which includes materials, workers, soil, watering, etc. be executed Previously, from the beginning of the work, the seams should be cleaned up to 3 cm, then the work should be started. At the end of the work on the stones, the excess material should be cleaned in its correct shape. For more clarification, refer to paragraph 4.05 of the technical specifications.		468	M2						
9	Installation of waterproof PCC concrete (1:4): with positive aspects under the supervision of the supervising engineer.		12	m						
	Total Cost in Afg Total Cost in USD		,,2			0 Afs		-		
epared by						\$0	//4 \$0	/		

Name: Position:

Sayed Zaki Sadat Survey & Design Engineer

Signature:

24,04,2025

Review and Checked by:

Name:

Sayed Najib Jalal

Position:

Survey & design Coordinator

Signature:

Authorized by:

Name: Eng.Ab.Wali Muslin
Position: Manager Technical Coordination Vn

Signature:

Approved by

Name: Engl Shah Wali
Position: Deputy Director (Head of Program

Signature:

Program / Technical Unit 2025

DACAAR



Program/Technical & Coordination Unit Survey & Design Team

Khwaja jamal Check Dam Drawings



Project Location:

Province: Helmand

District:.....Nawzad

Village:..... Khwaja jamal

Date: April 2025



LIST OF DRAWINGS

DISCRIPTION	DRAWING NO.
LIST OF DRAWINGS	01
LEGEND AND ABBREVIATIONS	02
TECHNICAL SPECIFICATION	03
TOPO PLAN	04
Site Plan	05
Plan Of Check Dam	06
Section A-A,B-B,C-C	07
Section D-D,H-H	08
Excavations	09
Cross Section	10
Long Section	1 1

	Funded By	UNODC	Village Khwaja jamal	Survey by Eng. Sayed Zaki Sadat Drawn & Designed by Eng. Sayed Zaki Sadat	Sheet Index Project Title CheckDam	
DACAAR / PROGRAM	I I I I I I	DACAAB	District Nawzad	Reviewed By Eng. Sayed Pail Sadat Reviewed By Eng. Sayed Najib Jalal	Scale Drawing Title LIST OF DR	AWINGS
-	Implemented By	DACAAR	Province Helmand	Checked & Approved By Eng. Abdul Wali Muslih	Date: April-2025	



LEGEND:-

ABBREVIATION:-

J	LEGEND:-			ABBREVIATIO	IATION:-			
		Center Line	Av	AVERAGE	ST	STATION		
◀—	1/2	Direction of flow	BM	BENCH MARK	THK	THICKNESS		
		Grouted Stone Masonry/Pitching Section	В	WIDTH	TYP	TYPICAL		
		Mass concrete Section	C/C	CENTER TO CENTER	HFL	HIGH FLOOD LEVEL		
	_	Brick Masonry	D	DEPTH OF WATER	U/S	UPSTREAM		
	1	P.C.C Block	DRG	DRAWING				
		Gabion			YRS	YEARS		
	-	Gabion Section	DIA, Ø	DIAMETER	Q	DESIGN DISCHARGE		
, , , , ,		Wash/River Bed Material	D.W.L	DESIGN WATER LEVEL	W.L	WATER LEVEL		
	_	Geotextile Mattress	D/S	DOWNSTREAM	N.T.S	NOT TO SCALE		
		Plain Cement Concrete	EL.	ELEVATION				
en,		Reinforced Cement Concrete	F.B	FREE BOARD				
* * * * * * * * * * * * * * * * * * * *	_	Bank Protection	HFL	HIGH FLOOD LEVEL				
	-	Compacted Soil	HT.	HEIGHT				
$\mathbb{M}_{\mathbb{Q}}$		Hill	H.G.L	HYDRAULIC GRADE LINE				
M.W.L	—	H.F.L / M.W.L	KM, km	KILOMETERE				
100.00	_	Elevation of the point is (100m) in section veiw						
\$ 100.00	-	Elevation of the point (100m) in Plan view	M ,m	METRE				
ST-1	·	Traverse Station	Chkd Apprvd	CHECKED APPROVED				
B.M-1		Benchmark	M.W.L	MAXIMUM WATER LEVEL				
<u> </u>		Lined Slope	MIN	MINIMUM	SCALE 1:200 (A3)	CENTEMETERS 00 300 400 500		
57777		Earthen Slope	No(s)	NUMBER(S)	SCALE 1:100 (A3)	CENTEMETERS 20 30 40 50		
[<u>-</u> 1111]			N.G.L	NATURAL GROUND LEVEL	SCALE 1:10 (A3) 0	CENTEMETERS 50 100		
		Ground Level	P.C.C	PLAIN CEMENT CONCRETE		CENTEMETERS 00 150 200		
-3	_	Stone Pitching/Rip Rap	R.C.C	REINFORCED CEMENT CONCRETE	SCALE 1:50 (A3)	CENTEMETERS		

Notes:

- 1- All dimensions are in cm or as specified on drawing.
- 2- For concrete class and stone masonry type refer to Contract Specifications.
- 3- All cut-offs to be constructed against undisturbed soil.
- 4-Location of the structure, setting out and elevations to be confirmed by the WMD representative before construction.
- 5-The contractor shall construct and maintain all necessary
- channels, diviersion and other temporary works necessary to ensure that irrigation water supplies are not interrupted during construction works.
- 6-All elevations are based on local benchmark.
- 7-Coordinates and elevatoin of local bechmark are attached to every single site.
- 8-Contraction joint in concrete coping at wall top shall be provided at 1.0m centers 9.Contraction joint in concrete base slab shall be provided at 2m centers.
- 10-Minimum concrete cover to steel reinforcement shall be 50mm.
- 11-Steel reinforcement shall have a minimum yield stress of 250N/mm2.
- 12-For retaining wall more than 12m in length, expansion joint shall be provided at 12m centers.
- 13-Abbreviations used:
- GI stands for galvanized iron
- EW stands for each way
- EF stands for each face
- FB stands for free board
- Dia stands for diameter
- MS stands for mild steel

	Funded By	UNODC	Village Khwaja jamal	Survey by	Eng. Sayed Zaki Sadat	- (cce	Sheet Index	Project Title	CheckDam
DACAAR / PROGRAM	E = 30		District Nawzad	Drawn & Designed by Reviewed By	Eng. Sayed Zaki Sadat Eng. Sayed Najib Jalal	/ Scale \	02	Drawing Title	ABBREVIATION
-	Implemented By	DACAAR	Province Helmand	Checked & Approved By	Eng. Abdul Wali Muslih			Date :	April-2025

BRIEF TECHNICAL SPECIFICATIONS



CONCRETE WORKS:

- 1 All air entraining plain cement concrete should be M-200 by wright or be as specified on the drawings.
- 2 All PCC to have cement, sand and aggregate as specified on the drawings.
- 3 Concrete design should be based on a compressive strength of fc = 200kg/cm2 or as specified on the drawings.
- 4 Weight per unit volume of concrete W=2400kg/m3.
- 5- Sand or fine aggregate shall be free from salt, Alkali, Calcium sulphate or Vegetation and it shall not contain more than 0.5 percent by weight clay.
- 6 Aggregate:- Coarse aggregate shall consist of crushed gravel with the maximum size of 20mm
- 7 The maximum slump for concrete should be between (5 7.5)cm. (For different concrete type refer to general specification).
- 8 To increase the workability of the concrete provide the chemical admixture (Super plasticizer, If required).
- 9 Water used for concrete mixture and concrete curing shall be from a source approved by the Engineer and at the time of use shall be free from contaminants.
- 10- Concrete compaction should be done by using concrete vibrator at the time of pouring in such a way to form a solid compact concrete.
- 11- Concrete curing should by continued for 28 days.
- 12- During cold weather concreting should be stopped or the contractor has to consider cold weather concreting procedure as accepted by the Engineer. (Or refer to general specification).
- 13- Concrete shuttering / formwork should be of steel or wooden type.
- 14- Concrete shuttering can be removed as per below minimum duration: Side of beams, Walls, Columns (16 - 24 Hours). Forms from beneath the slabs (Spaning up to 6m.) 14 Days. Forms from beneath the slabs (Spaning above 6m.) 21 Days
- 15- All air entrained concrete with 4.5% 7% of air volumes should be used instead of normal concrete works by adding approved admixture.
- 16- All RCC should be M-25.
- 17- All blinding PCC shall be M-10.
- 18- Reinforcement yield strength fy shall not be less that (2500kg/cm2).

MASONRY WORKS:

- 1 Plum / Mass air entraining concrete shall contain a maximum of 40% stone with a maximum stone size as 20cm.
 The concrete ratio shall be M-20.
- 2 Stone for Stone masonry, Gabion and grouted stone pitching should be of good quality and approved by Engineer.
- 3 All stone masonry for foundations should be with ratio of (1:3).
- 4 All masonry cutoff wall shall be with (1:3) Cement sand mortar or as specified on the drawing.

EARTH WORKS:

- 1 Backfilling material should be properly tested and selected to be suitable as per standard practice.
- 2 For backfilling maximum thickness of each loose soil layer should not more than 15cm. According to general specification.
- 3 Standard compaction tests should be carried out for the backfilling.
- 4 The percentage of compaction should be not less than (92 95)% of the maximum dry density of selected material by the Engineer.


GABION WORKS:

- 1 Stone size for gabion shall range from (20 30cm) dia. According to general specification.
- 2 Galvinized iron wier of specified thickness (2.7-3.0)mm Should be properly woven and knotted together to form the required mesh in hexagonal / rectangular shape of size (8 10cm) for gabion basket and (10 12cm) for gabion mattress to fabricate gabion boxes to the saftsfaction of the Engineer.
- 3 Principal wire along the gabion edges (Selvedges) for gabion boxes should be of galvanized iron having minimum thickness of (4mm).
- 4 Gabion galvanized iron wire tensile strength should be (350 575 N / mm2).

OTHERS:


- 1 Bitumen coating should be used in all contraction / Expansion joints.
- 2 All quality control field tests should be carried out by the contractor in a specified laboratory as accepted by the client.
- 3 Construction joints for PCC and masonry walls should be provided as (15 20m) center to center.
- 4- All diversions and flood protection works is contractor responsibility,

	Funded By	UNODC	Village Khwaja jamal	Survey by Eng. Sayed Zaki Sadat Drawn & Designed by Eng. Sayed Zaki Sadat	Cour	Scale Sheet Index	Project Title	CheckDam
DACAAR / PROGRAM	T 1	DAGAAB	District Nawzad	Reviewed By Eng. Sayed Najib Jalal		Meter 03	Drawing Litle	BRIEF TECHNICAL SPECIFICATIONS
2	Implemented By	DACAAR	Province Helmand	Checked & Approved By Eng. Abdul Wali Muslih			Date:	April-2025

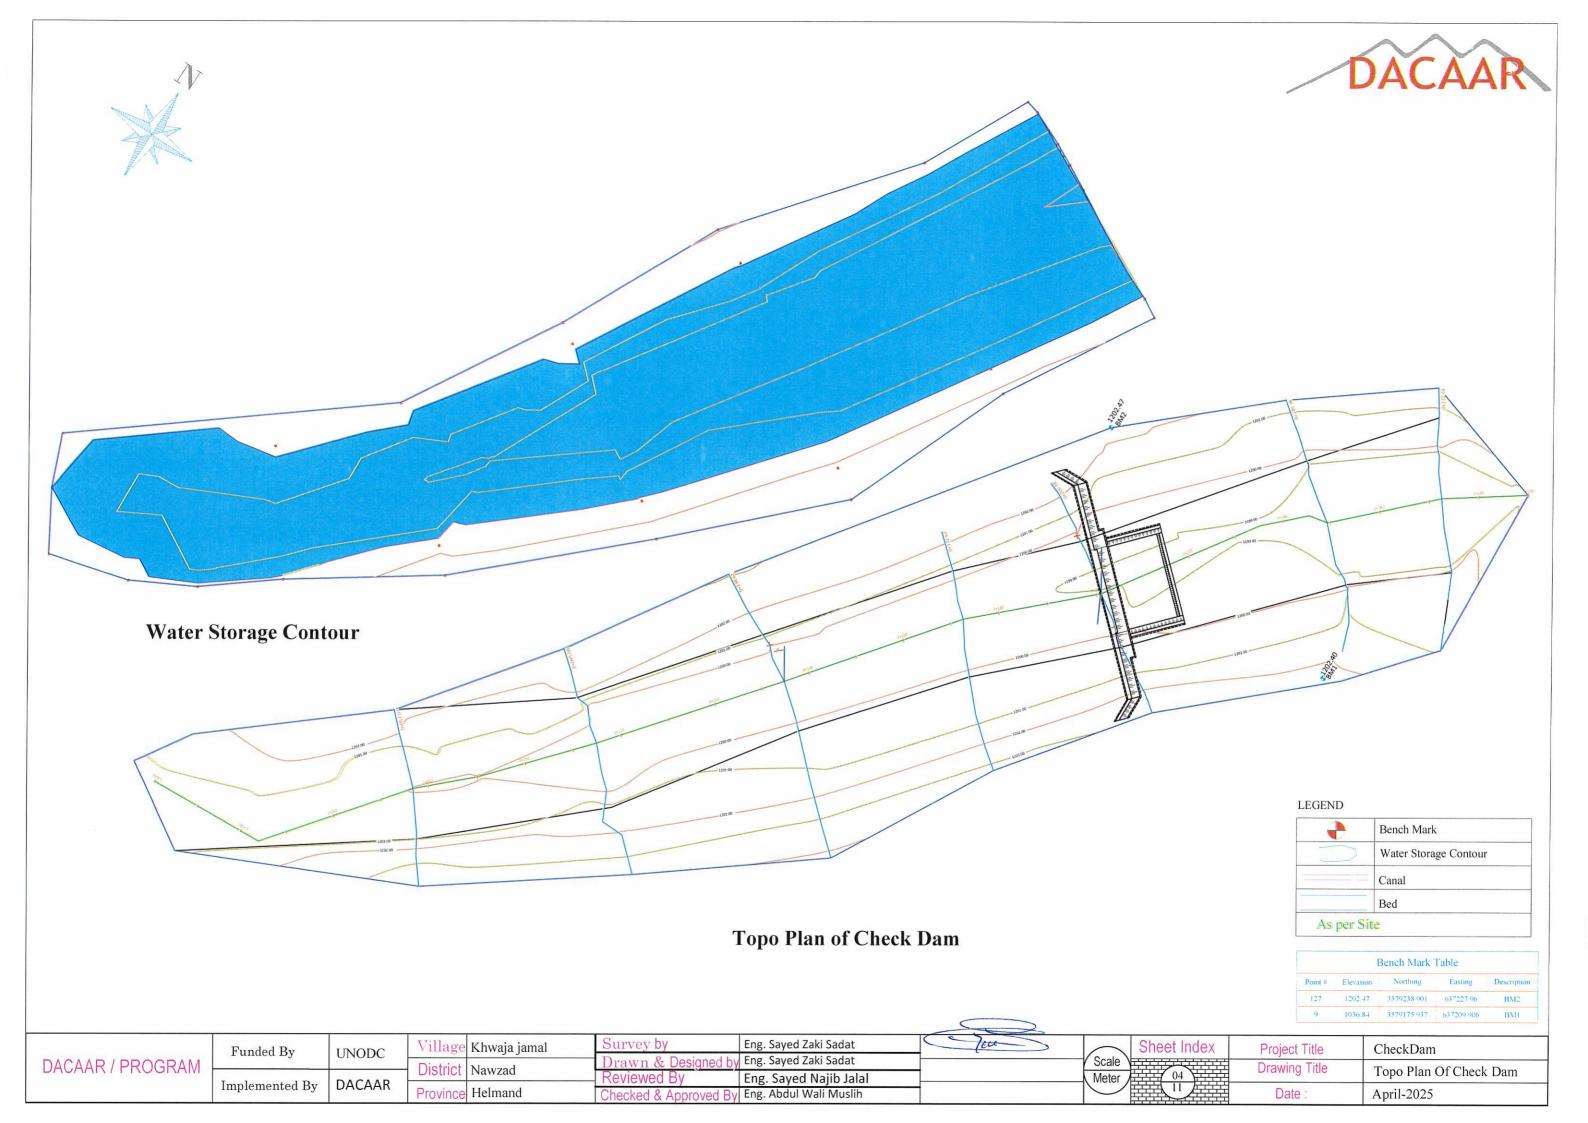





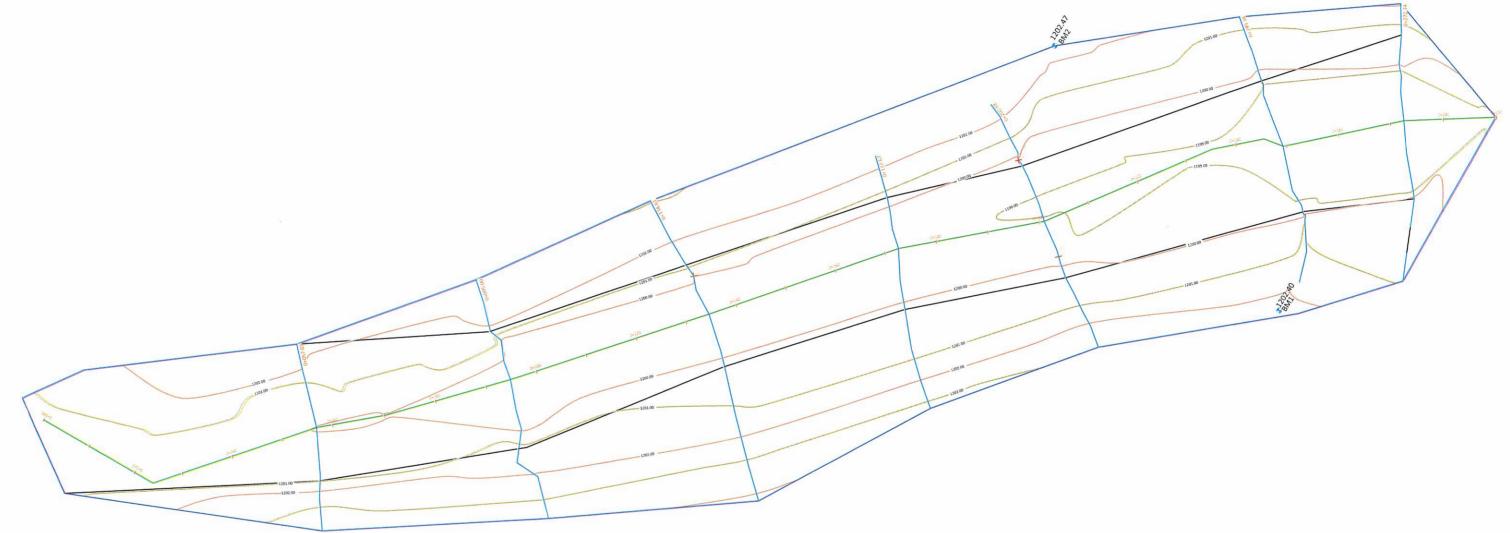

Site Plan of Check Dam

LEGEND

	Bench Mark
	Water Storage Contour
	Canal
	Bed
As per Si	te

Bench Mark Table									
Point #	Elevation	Northing	Easting	Description					
127 1202 47		3579238 901	637227 96	BM2					
9	1036.84	3579175 937	637209 906	BMI					

DACAAR / F	ROGRAM
------------	--------

Funded By	UNODC	L
Implemented By	DACAAR	


	Village	Khwaja jamal
_	District	Nawzad
₹	Province	Helmand

	Survey by	Eng. Sayed Zaki Sadat
	Drawn & Designed by	Eng. Sayed Zaki Sadat
	Reviewed By	Eng. Sayed Najib Jalal
ì	Checked & Approved By	Eng. Abdul Wali Muslih

Scale Scale Meter 05

Project Title	CheckDam
Drawing Title	Site Plan Of Check Dam
Date:	April-2025



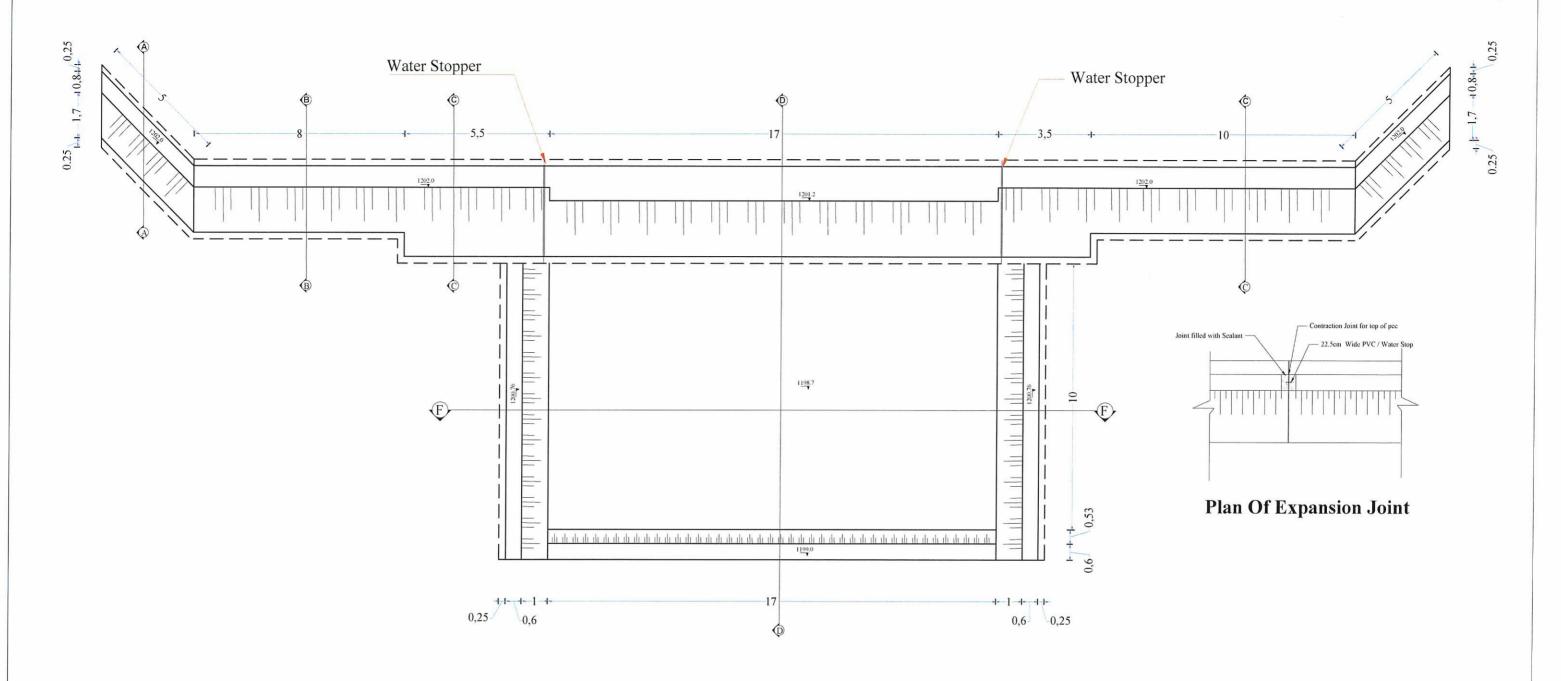


Plan Of Check Dam

Note:


- All dimensions are in M.
- All Excavated material can be use it upstream and downstream faces fillings with 90% Compaction. Filling layers must not be Pave more than (15-20)cm thickness.

	Funded By	UNODC	Village Khwaja jamal	Survey by En	ng. Sayed Zaki Sadat	- lau	Sheet Index	Project Title	CheckDam
DACAAR / PROGRAM			- District Nawzad	DIAWII & Dodigilou by	ng. Sayed Zaki Sadat ng. Sayed Najib Jalal	-	Scale Meter 06	Drawing Title	Plan Of Check Dam
	Implemented By	DACAAR	Province Helmand		ng. Abdul Wali Muslih			Date :	April-2025

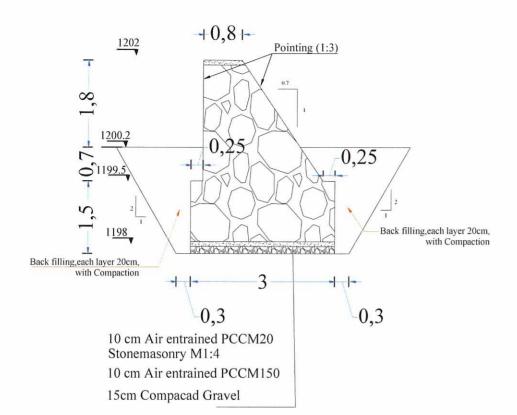

Detail drawings of Check Dam structure with cutting & filling at the deferent location

O Section B

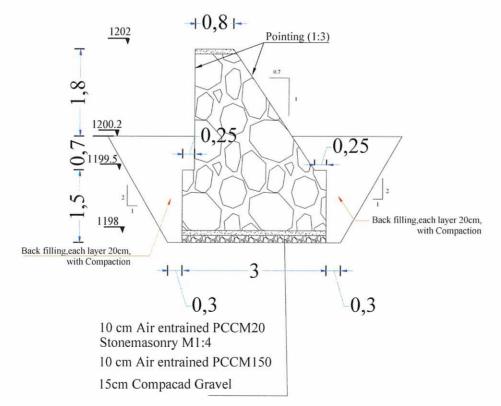

+0,8+ 1202 Pointing (1:3) 3 0,25 RB=1199 F-1,35 -10,85F 1198.15 1196.8 Back filling,each layer 20cm, with Compaction นักนักนักนักนักนักนักนักนักนักนักนักนัก Back filling,each layer 20cm, with Compaction 3,9 10 cm Air entrained PCCM20 0,3 Stonemasonry M1:4 10 cm Air entrained PCCM150

Detail drawings of Check Dam structure with cutting & filling at the deferent location

15cm Compacad Gravel


O Section C

Detail drawings of Check Dam structure with cutting & filling at the deferent location


O Section A

	Funded By	UNODC	Village Khwaja jamal	Survey by	Eng. Sayed Zaki Sadat	Tou	Sheet Index	Project Title	CheckDam
DACAAR / PROGRAM	T direct Dy	UNODE	Dietriot Named	Drawn & Designed by	Eng. Sayed Zaki Sadat	S	cale Virginia	Drawing Title	
BROKKITTIOOKKIII	T 1 (1D	DACAAB	District Nawzad	Reviewed By	Eng. Sayed Najib Jalal	M	eter 07	Drawing Title	Detail drawings of Check Dam
-	Implemented By	DACAAR	Province Helmand	Checked & Approved By	Eng. Abdul Wali Muslih	7		Date:	April-2025




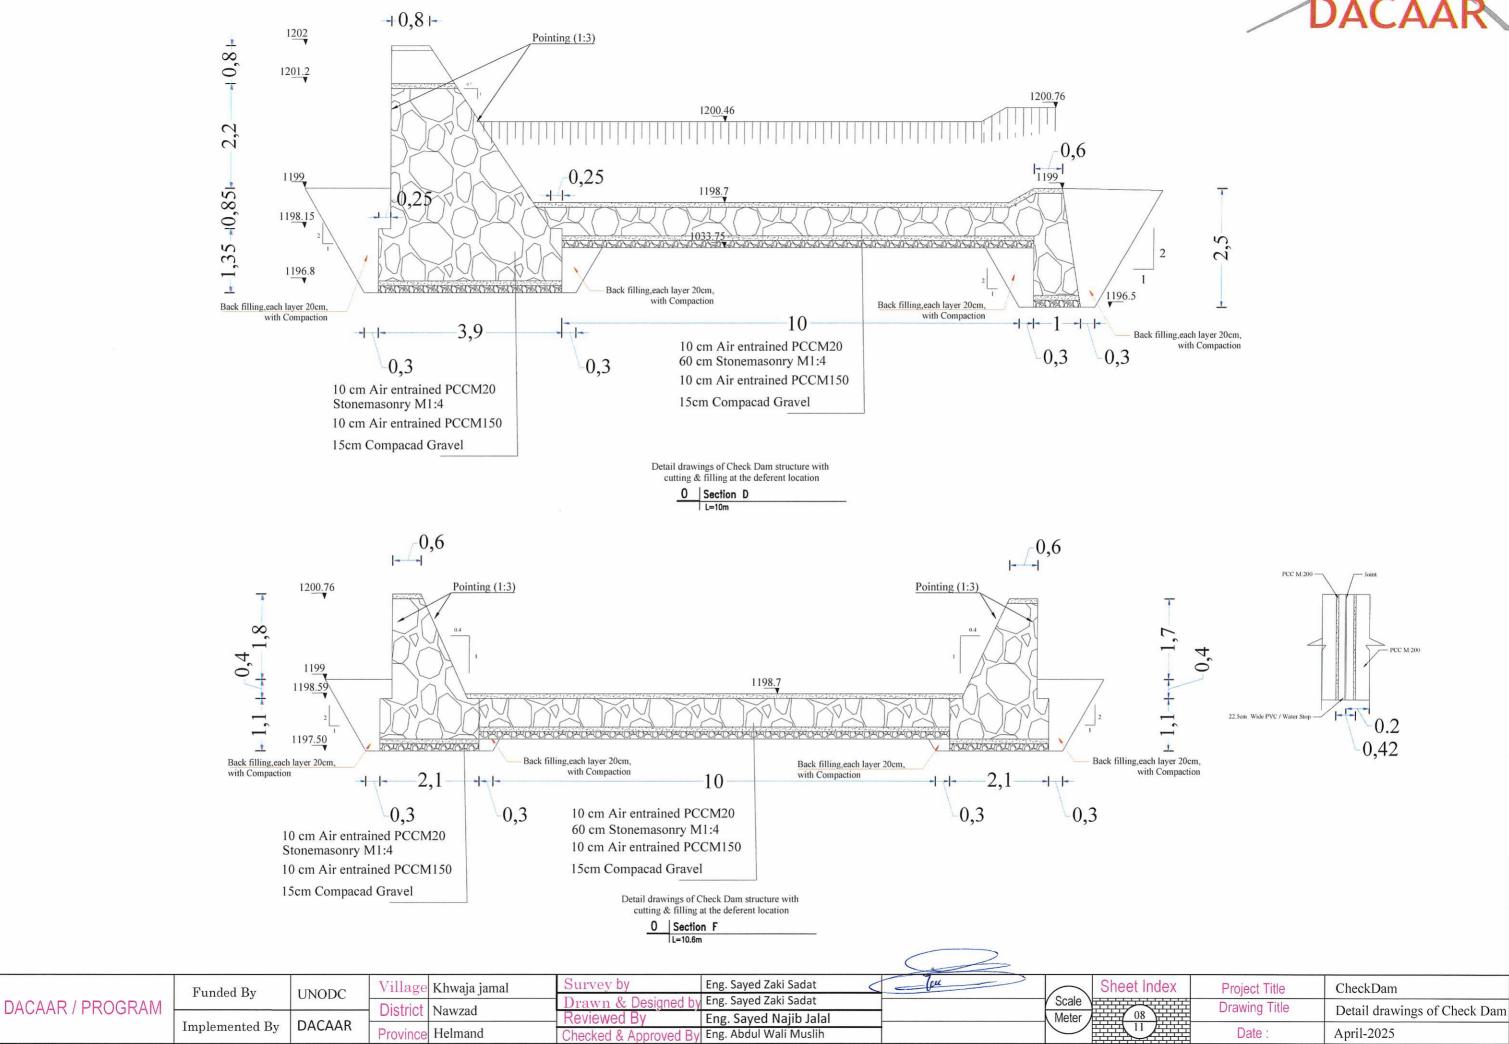



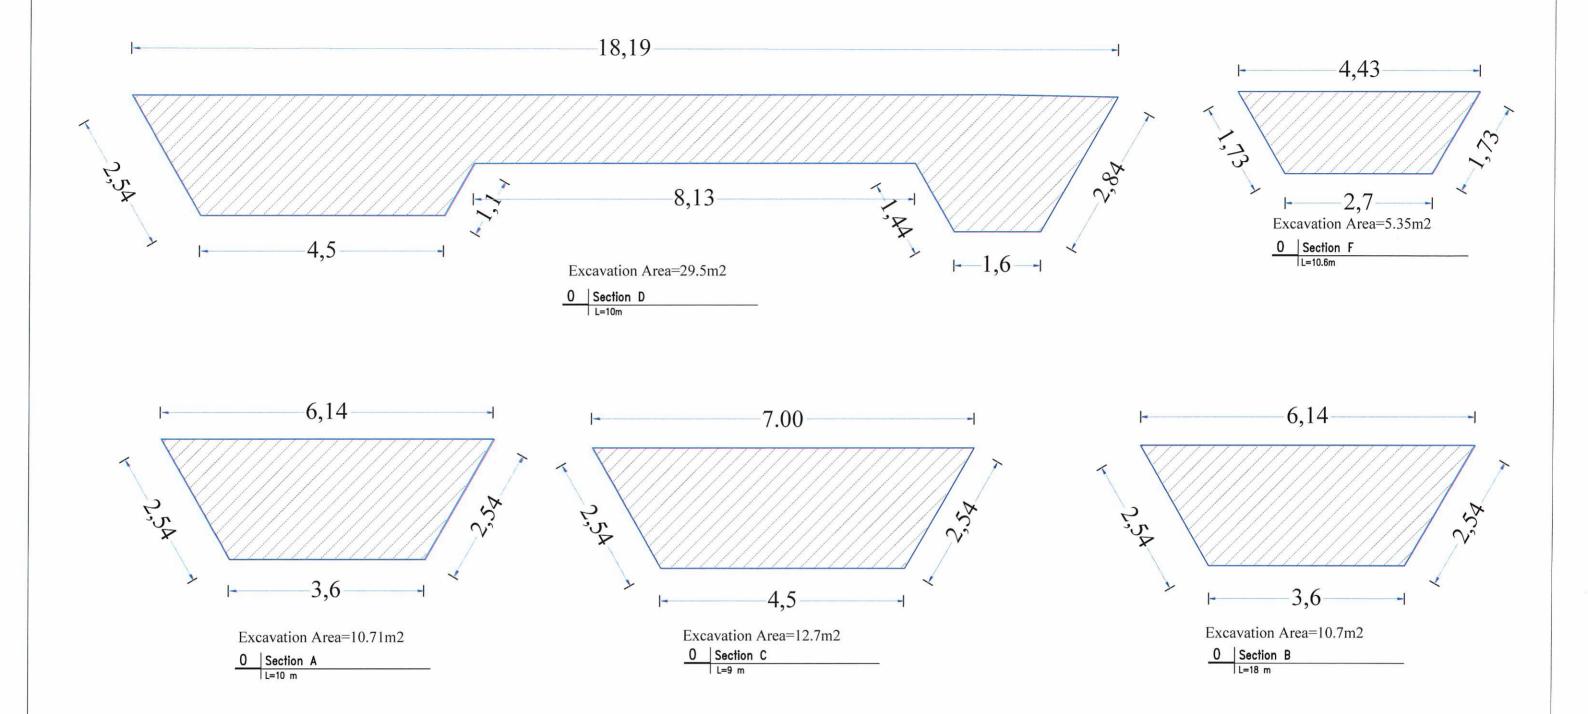


- 8		Funded Du	LINIODO	Village	Khwaja jamal	Survey by	Eng. Sayed Zaki Sadat	
DACAAR / PROGRAM	Funded By	UNODC		3 3	Drawn & Designed by	Eng. Sayed Zaki Sadat		
	Incomband Des	DACAAR	DISTRICT	Nawzad	Reviewed By	Eng. Sayed Najib Jalal	_	
		Implemented By	DACAAN	Province	Helmand	Checked & Approved By	Eng. Abdul Wali Muslih	

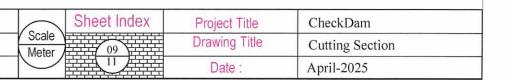



PROJECT PROFILE

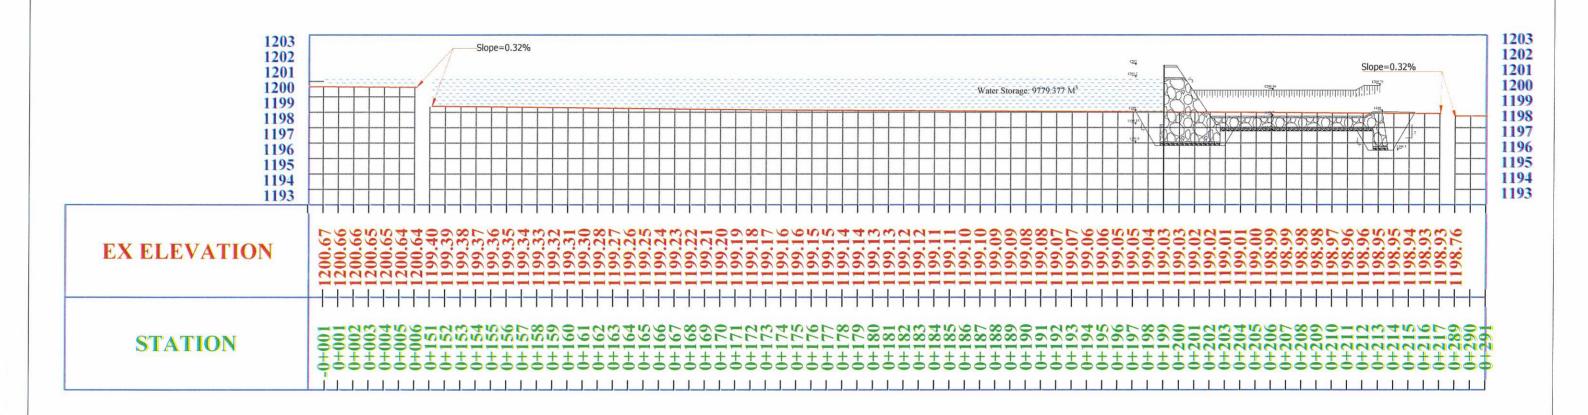


KHWAJA JAMAL CHECK DAM ON RIVER L-SECTION

	Funded By	UNODC	Village Khwaja jamal	Survey by	Eng. Sayed Zaki Sadat	= Tou ->	Sheet Index	Project Title	CheckDam
DACAAR / PROGRAM	1 dilucu by	UNODC	District Newsod	Drawn & Designed	by Eng. Sayed Zaki Sadat		Scale Scale	Drawing Title	I SECTION
BAOAARTIROGRAM	Implemented Dr	DACAAR	District Nawzad	Reviewed By	Eng. Sayed Najib Jalal		Meter 10	Drawing rido	L- SECTION
4	Implemented By	DACAAN	Province Helmand	Checked & Approved	By Eng. Abdul Wali Muslih			Date:	April-2025



0+200.88

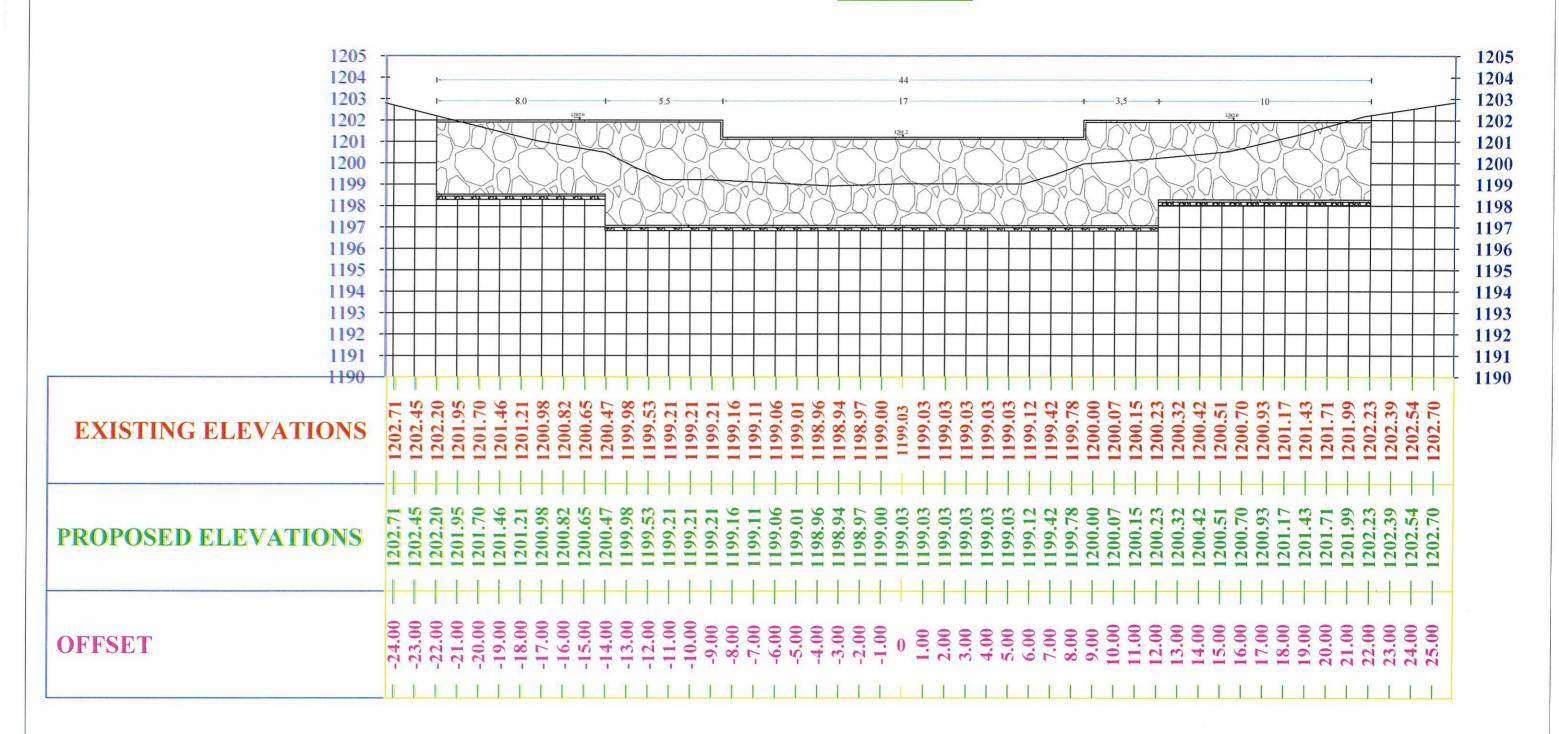

KHWAJA JAMAL CHECK DAM ON RIVER X- SECTION AT CH:0+200.88

~ ~ ~ × * * * * * * * * * * * * * * * *	Funded By	UNODC	Village Khwaja jamal	Survey by	Eng. Sayed Zaki Sadat	The state of the s	Sheet Index	Project Title	CheckDam
DACAAR / PROGRAM			District Nawzad	— Reviewed By	Eng. Sayed Zaki Sadat Eng. Sayed Najib Jalal		Meter 11	Drawing Title	X- SECTION AT CH:0+142.46
-	Implemented By	DACAAR	Province Helmand	Checked & Approved B	y Eng. Abdul Wali Muslih			Date:	April-2025