

Main Office

Golayee Wazirabad PO Box 208

REQUEST FOR QUOTATION Kabul, Afghanistan Construction of Check Dam for DACAAR Program UNODC Project

موبایل: ۹۳۷۰۰۲۸۸۲۳۲+

ايميل: dacaar@dacaar.org

وبسایت: www.dacaar.org

Phone: +93 202230752 Mobile: +93 700288232 E-mail: dacaar@dacaar.org Website: www.dacaar.org

in Ghoryan Village Nawzad District of Helmand Province

درخواست آفر برای اعمار و ساخت چک دم برای پروگرام داکار پروژه UNODC در قریه غوریان ولسوالی نوزاد والایت هلمند

Date: May 12, 2025

DACAAR RFQ 30 PRF-313/UNODC/2407-UNODC/UHLA1.1.1/05.2025

DACAAR needs Construction of Check Dam in Ghoryan Village Nawzad District of Helmand Province and invites ولايت هلمند ضرورت دارد، و از تمام علاقمندان واجد شرایط interested parties to submit their sealed offers for the required job mentioned in Annex (I).

داکار بر ای اعمار و ساختمان یک جک دم که در ضمیمه (I) از آن به تفصیل ذکر گردیده در قریه غوریان ولسوالی نوزاد تقاضا بعمل میآورد تا آفر های سربسته شانرا قبل از معیاد تعین شده به دفتر داکار بسیار ند

The offers must be submitted to DACAAR Main Office Logistics Unit located in Street No. 12, Taimani Project, Qala-e-Fathullah, Kabul Province till 4:00 PM May 23, 2025.

آفرها بايد الى تاريخ 23 مى 2025 ساعت 4:00 عصر به شعبه لوجستیک دفتر مرکزی داکار واقع پروژه تایمنی پایکوب نصوار سرك 12 قلعه فتح الله ولايت كابل سيرده شود.

The offers will be opened on May 25, 2025 at 10:00am in DACAAR Main Office, Kabul Province and the winner of the biding will be notified shortly after the bid opening session.

مجلس آفرگشایی ساعت 10:00 قبل از ظهر 25 می 2025 در دفتر مرکزی داکار در ولایت کابل صورت میگیرد که متعاقباً برنده داوطلبي در اسرع وقت اطلاع خواهد يافت.

Please use Annex (III) for Technical Specification, Annex (II) for Work Plan and Annex (I) for Financial purposes.

لطفاً ضميمه (I) را بخاطر ارايه آفر، ضميمه (II) را بخاطر یلان کاری و ضمیمه (III) را بخاطر مشخصات تخنیکی مشاهده نمائيد

Terms and Conditions for Participation/Bid Winner

1. Contractor should Construct the Check Dam in Ghoryan Village Nawzad District of Helmand Province based on completion plan mentioned in Annex (II).

شرایط قرارداد برای برنده داوطلبی/ اشتراک کننده گان

- 1. قرار داد گیرنده مکلف است تا اعمار جک دم را که در قربه غوريان ولسوالي نوزاد ولايت هلمند موقعيت دارد، طبق پلان کاری که در ضمیمه (۱۱) ذکر گردیده تکمیل نماید.
- 2. Priority is given to construction companies.

- حق او لویت به شرکت های ساختمانی داده میشود.
- 3. Similar works experience as prime contractor in the construction of at least one works in nature and complexity equivalent.
- داشتن تجربه کاری مشابه حداقل یک پروژه که ماهیت و پیچیدگی آن مشابه به این بروژه باشد.
- 4. Provision of all tools and equipment's required for the Construction of Check Dam belongs to the contractor.
- 4. تهیه تمام وسایل و مواد برای اعمار و ساختمان چک دم معه اعاشه و اباطه بدوش قرار داد گیرنده میباشد.
- 5. Payment will be made within 15 working days after technical team confirmation and successfully completion of the contract.
- 5. برداخت بول بعد از تصدیق بخش تخنیکی داکار و تکمیل نمودن مؤفقانه قرارداد در مدت 15 روز كارى اجرا ميگردد.

- 6. The bid winner must deposit 10% amount of total contract value to DACAAR bank account as a Contract Performance Guarantee before signing the contract, the mentioned amount only refundable after successful completion of the contract.
- 7. In case of delay in contract completion without any logical reasons, 0.5% of total value of the remaining work will be deducted from the payment. This penalty
- 8. Quotations should be valid for 60 official days.

will charge per each official day of delay.

- Prices shall be given in Afghanis (AFN) and must include all duties, transport cost, loading and unloading costs. Offers without sign and stamp will not be accepted. Manipulated/overwritten offers will automatically be rejected.
- 10. DACAAR's technical team (Site Engineer) will check quality of work. If it is not according to the specifications, DACAAR Technical Team has reserved the right to terminate the contract without any compensation paid to the contractor.
- 11. 2% Tax will be applicable on the companies that has valid business license and 7% Tax will be applicable on the companies that have invalid business license, or on individuals who do not have business license, will be deducted from the contractor as a withholding tax and DACAAR will pay that amount to Ministry of Finance, the amount starts from (1 AFN).
- 12. DACAAR does not accept sub-contract, in case if it is found that the contract has given to sub-contracting contractor, the contract will automatically be terminated and the supplier will lose their performance guarantee and no compensation will be paid to the contractor.
- 13. DACAAR will not be responsible for any changes occurred during the contract such as (increment in custom duties, exchange rate etc.)

- 6. برنده داوطلبی مکلف است تا %10 مجموع ارزش قرارداد را بشکل تضمین بانکی از اجرای کامل و مؤفقانه قرارداد قبل از امضأ آن به حساب بانکی داکار بپردازد. مبلغ متذکره در صورت اجرأ مؤفقانه قرارداد قابل باز پرداخت میباشد.
- در صورت تأخیر در تکمیل قرراداد بدون عذر موجه در وقت معینه آن، مبلغ %0.5 از هر روز کار تأخیر شده بطور جرمانه از مجموع ارزش قرارداد اخذ میگردد.
- 8. قیمت داده شده باید برای مدت 60 روز کاری مدار اعتبار باشد.
- و. قیمت ها به افغانی داده شود و باید شامل مالیات، انتقال، قیمت بارگیری و تخلیه باشد و قیمت هائیکه بدون مهر و امضا قابل قبول نمیباشد. آفرهای قلم خورده گی بطور اتومات رد میگردد.
- 10. هئیت تفتیش و بررسی داکار کیفیت کار را به اساس قرارداد چک و ملاحظه نموده در صورتیکه مطابق به مشخصات قرارداد نباشد، داکار حق دارد تا قرارداد را بدون جبران کدام خساره فسخ نماید.
- 11. %2 مالیه برای شرکت هائیکه دارای جواز با اعتبار میباشد، و %7 مالیه برای شرکت هائیکه معیاد جواز آن تکمیل گردیده باشد، و یا اشخاصیکه جواز ندارند توسط داکار وضع گریده و به وزارت مالیه پرداخت میشود، آغاز مبلغ از (1 افغانی).
- 12. داکار به هیچ عنوان قرارداد دست دو را نه پذیرفته، در صورت وقوع چنین حالت قرارداد بصورت اتومات فسخ و قرارداد گیرنده پول تضمین و حق اجوره خویش را از دست میدهد.
- 13. داکار به هیچ عنوان مسؤولیت بلند رفتن مالیات گمرکی، اسعار خارجی وغیره مواردی که باعث بلند رفتن قیمت در جریان قرارداد گردد ندارد.

- 14. DACAAR (Logistics Unit) adheres to National and International laws on child labour DACAAR makes sure all its suppliers and vendor abide by such laws preventing child labour in all DACAAR activities countrywide.
- 14. دفتر داکار (شعبه لوژیستیک) با درنظرداشت قوانین ملی و بین المللی برای جلوگیری از کار کودکان مصمم بوده و سعی میکند که تمام فعالیتهای تهیه کننده گان و مشتریان این اداره به این اصل پابند باشند.
- 15. The Humanitarian Organizations (HO) may conduct on-site visit in the contractor's premises (or may take similar measures) to ensure compliance.
- 15. سازمان های بشر دوستانه (HO) ممکن است تا از محلات و سایت ها به بخاطر اطمینان خاطر و تطبیق درست کار توسط قرار داد گیرنده بازدید بعمل آورده ویا ممکن است اقدامات مشابه را انجام دهد.
- 16. DACAAR has a zero-tolerance policy on sexual exploitation, abuse and harassment, which is defined and described in the policy document "DACAAR policy on preventing and handling sexual exploitation, abuse and harassment".
- 16. داکار دارای پالیسی عدم تحمل در مورد سؤ استفاده، بد رفتاری و آزار و اذیت جنسی میباشد و موقف داکار در همچون مسایل بطور تفصیلی در پالیسی مذکور تشریح شده است.
- 17. Award of contract will be based on the price, capacity and potentiality of bidder which will be decided after evaluation of the company; it is the right of DACAAR to make the decision of awarding contract.
- 17. برنده شدن قرارداد نظر به قیمت، توانائی و ظرفیت کاری داوطلب بوده و بعد از بررسی کمپنی صورت خواهد گرفت. البته داکار تنها حق تصمیم گیری در این زمینه را دارا میباشد.

For more details, please visit DACAAR Logistics Unit Main Office Kabul, Sunday through Thursday, from 8:00am to 03:00 PM or contact on below Email Addresses: jamal@dacaar.org or wasimullah@dacaar.org

Yours Sincerely, Manager – Logistics Unit

Date: May 12, 2025

ANNEX (I)

فورم ارایه آفر /Budget Breakdown

DACAAR RFQ 30 PRF-313/UNODC/2407-UNODC/UHLA1.1.1/05.2025

Construction of Check Dam for DACAAR Program UNODC Project in Ghoryan Village Nawzad District of Helmand Province:

S.N	Item Name and Specification	Unit	Quantity	Unit Price (AFN) (Including 2% or 7% Government Tax, transportation cost)	Total Price (AFN) (Including 2% or 7% Government Tax, transportation cost)
1	Excavation normal and removal of excess materials up to 500M	M^3	1,263		
2	Stone Masonary Work 1:4	M^3	580		
3	PCC 1:1.5:3	M^3	40		
4	PCC 1:2:4	M^3	30		
5	Denese Filling with quality will grade	M^3	589		
6	Pointing 1:3	M^2	345		
7	Gravel in Foundation with 15cm thickness	M^3	60		
8	Installation of Water Proof Concrete 1:4	M	13		
9	Installation of One Marble Sign Board 70*120cm	No	1		
	Grand Total: AFN	•			

Bidder Name:	اسم آفر دهنده:
Address and Stamp:	آدرس و مهر کمپنی
Contact No:	نمبر موبائيل
Email Address:	ايمل آدرسالمل آدرس
Delivery Period:	ز مان تحویل دهی

ANNEX (II) Tentative Work Plan/ پلان کاری تخمینی DACAAR RFQ 30 PRF-313/UNODC/2407-UNODC/UHLA1.1.1/05.2025

Construction of Check Dam for DACAAR Program UNODC Project in Ghoryan Village Nawzad District of Helmand Province:

S/No	Specifications	Unit	Quantity of Work	Start Date of the Contract	End Date of the Contract	
1	Excavation normal and removal of excess materials up to 500M	M^3	1,263			
2	Stone Masonary Work 1:4	M^3	580			
3	PCC 1:1.5:3	M^3	40			
4	PCC 1:2:4	M^3	30			
5	Denese Filling with quality will grade	M^3	589	Starts After DACAAR Contract Final Approval	August 30, 2025	
6	Pointing 1:3	M^2	345			
7	Gravel in Foundation with 15cm thickness	M^3	60			
8	Installation of Water Proof Concrete 1:4	M	13			
9	Installation of One Marble Sign Board 70*120cm	No	1			

ANNEX (III)

Technical Specification/مشخصات تخنيكى DACAAR RFQ 30 PRF-313/UNODC/2407-UNODC/UHLA1.1.1/05.2025 د پروژي د پلي کولو او تطبيق په اړه د شرکتونو لپاره عمومي تشريح ، لارښووني ، شرايط او اوځانګړتياوي

- 1- ټول ساختماني مواد باید داینجنیري نورم ، ډیزاین او معیار (ستنډرډ) مطابق وي او په ساحه کي هم په همدي مشخصاتو وساتل شي
- 2- د کارپه دوران کي امنيتي او حفاظتي مسايل په جدي توګه مراعات کړل شي لکه د کاريګرانو خولی ، بوټ ،دستکش کمربند....
 - 3- بهرني کارکونکي نشي کو لاي چې پرته د قانوني اسنادو څخه پدي پروژو کې کاروکړي
- 4- په هره پروژه کي بايد دپروژي اړوند فعاليتونو دثبت او ريکار ډ په موخه ژورنال په ساحه کي موجود وي او دپروژي په پاي کي ډاکار دفترته وسپارل شي
 - 5- قراردادکونکي شرکت مکلف دي چي د هري مياشتي په پاي کي د پروژي د پرمختګ راپور ترتيب او ډاکاردفتر ته وسپاري چي ترڅو په ګوته شي چي کاردپلان مطابق دي او که خير ؟ ترڅو پروژه پخپل وخت او زمان تکميل شي
 - 6-د سنگ کاری مصاله باید 4:1 وی او یه ساحه کی باید معیاری منک موجودوی .
 - 7- دهنگاف مصاله باید 1:3 وی
- 8- هغه ډبره (تیږه) چي په سنګ کارۍ کي په کاراچول کیږي باید پارچه او ماته شوی وي مخ ولري مقاومت ولري د کار په جریان کي باید د تیږو بافت په نظر کی ونیول شي ورته ډول ریګ او جغل باید د عضوي موادو خاوری او ګرد څخه پاک وي
- 9- سمنت بايد تازه وي او په ساحه كى د اينجنيري نورم او ستنډر د مطابق وساتل شي، په يو ستون كي بايد 5 بوجي څخه زيات سر په سرسټاك نشي
 - 10- دمصالي جوړول بايد په مکسر ماشين ترسره شي
- 11- هغه اوبه چي په ساختماني چاروکي استعماليږي بايد پاکي وي او کيفيت له نظره د تايد وړ وي مالګيني نه وي قلويت او تيزابيت يي د منلو وړ حد کې وي
 - 12- سنګ کاري او ټول سیمنټي فعالیتونو او کارونولپاره د کاردمقاومت او کلکوالي په هدف دوامداره هره ورځ اوبه ورکول شي لږتر لږه د ورځۍ 5 ځلی د 15-28 ورځو لپاره
 - 13- د کار په ساحه کي يواځي د پروژي پرسونل بايد وليدل شي او دغيرمسولو کسانوڅخه جدا مخنيوي وشي
 - 14- د پروژی د پرسونلو او کاري وسايلو ساتنه د شرکت مسوليت دي ډاکاريي هيڅ نوع مسوليت نلري
 - 15-شركت بايد د خپل شركت فكت شيت اودساحوي اينجنير CV د داوطلبي د فورمو سره يوځاى كړي
 - 16- شرکت باید د کاري پلان مطابق او ډاکار دفتر د ساحوي انجینر د سپارښتنو او هدایت په رڼاکی د پروژی کارونه سرته ورسوي
 - 17- د داوطلبي ټولو کمپنيانو او شرکتونو څخه جدا غوښتنه کوو چي ورکول شوي شرايط ښه مطالعه کړي ترڅوپه راتلونکي کي د عذر اوبهاني چانس نه وي او شکايت يي هم نه اوريدل کيږي
- 18- هیڅ شرکت او کمپني نشي کولي چي دا پروژه بل چاته په قرارداد ورکړي که داسي یو حالت رامنیځ ته شي قرارداد فسخ کیږي او دترسره شوي کار هیڅ معاوضه نه ورکول کیږي

20- ددي پروژي ټول کارونه د احجامو مطابق بايد ترسره شي ، کچيري احجام کم شي د قرارداد د قيمت مطابق به هزينه او قيمت وضع کيږي او هيڅ ډول اضافه کارونه نه اجرا کيږي بايد د ورکول شويو احجامو مطابق پروژه تکميل شي

21- شركت او كمپني نشي كولي چي په پروژه كي تغير او تبديل راولي ، دضرورت په صورت كي به د ډاكار له ساحوي او زون دفترونو سره شريک كيږي د لزوم په صورت كي به دمركزي دفتر دتايد څخه وروسته اجراكيږي

22- د پیسو تادیه د قرارداد مطابق د پروژي د 100% د تکمیل څخه وروسته د 15 ورځو په جریان کې د بانک له لاري اجرا کیږي

23- تادیه د پیسود ورکول شویو احجامو او په گوته شویو فعالیتونو مطابق ترسره کیږي او هیڅ ډول اضافه لګښتونه نه منل کیږي

24- شرکت باید ساحوي انجنیر د کاري تجربي په اساس ساحي ته توظیف کړي او پروژه په تخنیکي ډول تکمیل کړل شي

25- دکارله ساحي څخه د کندنکاري شويو موادو مناسب ځاي ته انتقالول او د ساحي پاک کاري د شرکت پوري اړه لري

26- د چک ډيم دهر ډول داوبو د ليکج (Leakage) مخنيوي دشرکت دنده او مسوليت دي

27- پرانه (ډکون) back filling لپاره مواد د انجنيري دنورم او ستنډر د مطابق او او 90٪ بايد متراکم شي (Compaction) اود انيجنيري نورم مطابق هره طبقه بايد د 20 سانتي متر په ضخامت

28- د طبعي پيښو په صورت کي ډاکار هيڅ ډول خساری او تاوان مسوليت نلري او د شرکت دنده ده چي د ورکول شويو احجامو مطابق پروژه تکميله کړي

29- دپروژي د کارپه جریان کي ډاکار د پرسونلو هیڅ نوع بیمه او یانور مصارف په غاړه نلري دا دشرکت مسولیت دي چي خپل پرسونلو حفاظتي تدابیر جدا په نظرکي ونیسي

30-کچیری د یو فعالیت په مجموعی قیمت کی د فی واحد د قیت سره تقاوت ولری نو د فی واحد د قیمت د اعتباروړدی او دی همدی په اساس به حساب ورکول کیږی

31-كوم قيمتونه چى د داطلبى په فورمه كى د شركت لخوا وركول كيړى شركت بايد ټول ابعاد په نظركى ونسى لكه وسايل ، كاركونكى د موادو ساتنه اوداسى نور

32-ورکول شوی نرخونه او قیمتونه کی انتقال بارگیری ماشین الات او همدار از ځینی ضمنی کارونه لکه دسلاب د مخنیوی لپاره د مسیر د تغیر او ماشین الاتو د انتقال لپاره موقتی لاره جوړول شرکت باید په نظرکی ولری

33-دکون (Filling) کی مواد او موادو تراکم کول شامل دی

DACAAR - Program

Technical and Coordination Unit/Survey and DesignTeam Bill of Quantity (BOQ)for Construction of Ghoryan CheckDam

Province: Helmand

Village:

District: Nowzad Ghorvan Subproject Name: Ghoryan Check Dam

Estimation Date: 13.01.2025

Submitting Date: 12.01.2025

village.	Ghoryan		Submitting Date: 13.01.2025						
No.	ltem	Activities %	Quantity	Unit	Unit cost Afs	Total cost Afs		tribution DACAAR, Af	
1	Mobilization: includes the price of all activities such as the transfer of personnel, tools, vehicles, field establishment office and other activities for the implementation of the project and demobilization.		1	LS			CIDOPERIO	DAGAAN, AIS	
2	"Excavating normal works: which means digging works that were done without hydraulic machines and removal of excess materials up to 500 meters or according to the instructions of the field engineer. For more clarification, refer to paragraph 2.02 of technical specifications		1,263	МЗ					
3	Dense filling" refers to the filling of material with the quality of Will Grade, which can be verified from one area and its density is not less than 90% of Proctor Mody Fide ATM. If the compaction is done by machine, the thickness of the soil should not be increased from 20 cents, in the images of compacting the soil by manual machines, its thickness should not be increased from 10 cents.		589	М3					
4	Stone Masonry work M(1:4): Wall stonework with a compromise of 1:4, with all its positive features, the stone must be solid, clean and free of dust according to the plan and opinion of the supervising engineer of the area.		580	M3					
5	15cm thick sea gravel in the lower part of the tahadab: preparing, pouring and compacting the gravel filter made of vale-graded materials, it is poured under the paving stones or gabions (first, the tahadab is tamped, then the sea gravel carpet, then the paving stones or gabion work should be started.) These materials are a combination of sea sand with sea gravel or crushed gravel, which is the combination of the same sand and well Graded gravel. Approval of materials and type of work should be approved by the field engineer.		60	М3					
6	PCC M(1:1.5:3):Concrete without spikes with 20 MPa brand preparation, pouring, compacting and watering of 20 brand concrete, including molding with positive things according to the plan, technical specifications and approval of the supervising engineer.		40	M3					
7	PCC M(1:2:4):Concrete without spikes with 15 MPa mark: preparation, pouring, compacting and watering of concrete mark 15, including molding with positive things according to the plan, technical specifications and approval of the supervising engineer.		30	МЗ					
8	Pointing,M (1:3): Pointing work is done with a ratio of cement and sand of 1:3, which includes materials, workers, soil, watering, etc. be executed Previously, from the beginning of the work, the seams should be cleaned up to 3 cm, then the work should be started. At the end of the work on the stones, the excess material should be cleaned in its correct shape. For more clarification, refer to paragraph 4.05 of the technical specifications.		345	M2					
9	Installation of waterproof PCC concrete (1:4): with positive aspects under the supervision of the supervising engineer.		13	m				/	
	Total Cost in Afg					0 Afs		1	
Prepared b	Total Cost in USD				Authorizas	\$0	\$0		

Prepared by:

Name: Position: Sayed Zaki Sadat

Survey & Design Engineer

Signature:

Review and Checked by:

Name:

Sayed Najib Jalal

Position:

Survey & design Coordinator

Signature:

Authorized by:

Name: Eng.Ab.Wali Muslih

Position: Manager Technical & Co

Signature:

Approved by:

Name: Eng. Shah Wali
Position: Deputy Director/Head of Program

Signature:

Program / Technical Unit 2025

DACAAR - Program Technical and Coordination Unit/Survey and DesignTeam Bill of Quantity (BOQ)for Construction of Ghoryan Ched/Dam

Bill of Quantity (BOQ)for Construction of Ghoryan CheckDam Province Helmand Subproject Name: Ghorvan Check Dam District: Nawzad Estimation Date: 13.01.2025 Ghoryan Village Submitting Date: 13.01.2025 Weeks S/N Description QNT Unit Mobilization: includes the price of all activities such as the transfer of personnel, tools, vehicles, field establishment office and other activities for the implementation of the project and demobilization. LS "Excavating normal works: which means digging works that were done without hydraulic machines and removal of excess materials up to 500 meters or according to the instructions of the field 1.263 m3 engineer. For more clarification, refer to paragraph 2.02 of technical specifications Dense filling" refers to the filling of material with the quality of Will Grade, which can be verified from one area and its density is not less than 90% of Proctor Mody Fide ATM. If the compaction is done by 589 m3 machine, the thickness of the soil should not be increased from 20 cents, in the images of compacting the soil by manual machines, its thickness should not be increased from 10 cents. Stone Masonry work M(1:4): Wall stonework with a compromise of 1:4, with all its positive features, the stone must be solid, clean and free of dust according to the plan and opinion of the supervising 580 m3 engineer of the area 15cm thick sea gravel in the lower part of the tahadab: preparing, pouring and compacting the gravel filter made of vale-graded materials, it is poured under the paving stones or gabions (first, the tahadab is tamped, then the sea gravel carpet, then the paving stones or gabion work should be 5 started.) These materials are a combination of sea sand with sea gravel or crushed gravel, which is 60 m3 the combination of the same sand and well Graded gravel. Approval of materials and type of work should be approved by the field engineer. PCC M(1:1.5:3):Concrete without spikes with 20 MPa brand preparation, pouring, compacting and watering of 20 brand concrete, including molding with positive things according to the plan, technical 40 m3 specifications and approval of the supervising engineer. PCC M(1:2:4):Concrete without spikes with 15 MPa mark: preparation, pouring, compacting and watering of concrete mark 15, including molding with positive things according to the plan, technical 30 m3 specifications and approval of the supervising engineer. Pointing,M (1:3): Pointing work is done with a ratio of cement and sand of 1:3, which includes materials, workers, soil, watering, etc. be executed Previously, from the beginning of the work, the seams should be cleaned up to 3 cm, then the work should be started. At the end of the work on the 345 m2 stones, the excess material should be cleaned in its correct shape. For more clarification, refer to paragraph 4.05 of the technical specifications. Installation of waterproof PCC concrete (1:4): with positive aspects under the supervision of the 13 m supervising engineer. Prepared by: Authorized by: Name: Sayed Zaki Sadat Eng.Ab.Wali Muslih Name: Position: Manager Technical & Coordination Unit Survey & Design Engineer Position: Signature: Signature: Review and Checked by: Approved by Name: Sayed Najib Jalal Name: Eng. Shah Wali Position: Survey & Design Coordinator Position Deputy Director/Head of Program Signature: Signature:

DACAAR



Program/Technical & Coordination Unit Survey & Design Team

Ghoryan Check Dam Drawings

Project Location:

Province: Helmand

District: Nawzad

Village:.... Ghoryan

- 7u

Date: Jan 2025



LIST OF DRAWINGS

DISCRIPTION	DRAWING NO.
LIST OF DRAWINGS	01
LEGEND AND ABBREVIATIONS	02
TECHNICAL SPECIFICATION	03
TOPO PLAN	04
Site Plan	05
Plan Of Check Dam	06
Section A-A,B-B ,C-C	07
Excavations	08
Cross Section	09
Long Section	10

	Funded By	UNODC	Village Ghoryan	Survey by Eng. Sayed Zaki Sadat Turner Sheet Index Project Title CheckDam	
DACAAR / PROGRAM	T 1		District Nowzad	Drawn & Designed by Eng. Sayed Zaki Sadat Reviewed By Eng. Sayed Najib Jalal Scale Meter Drawing Title LIST OF DRAY	WINGS
~	Implemented By		Province Helmand	Checked & Approved By Eng. Abdul Wali Muslih Date: Jan-2025	



T	an	TT	
H	GE:		١.
LL	UL.	LNL	/

ABBREVIATION:-

	LEGE	ND:-		ABBREVIATIO	N:-	
	_	Center Line	Av	AVERAGE	ST	STATION
-		Direction of flow	BM	BENCH MARK	THK	THICKNESS
	Sec. 317 - 30	Grouted Stone Masonry/Pitching Section	В	WIDTH	TYP	TYPICAL
	_	Mass concrete Section	C/C	CENTER TO CENTER	HFL	HIGH FLOOD LEVEL
	_	Brick Masonry	D	DEPTH OF WATER	U/S	UPSTREAM
		P.C.C Block	DRG	DRAWING		
	10 1	Gabion	2110	Samue	YRS	YEARS
	·	Gabion Section	DIA,Ø	DIAMETER	Q	DESIGN DISCHARGE
		Wash/River Bed Material	D.W.L	DESIGN WATER LEVEL	W.L	WATER LEVEL
(////		Geotextile Mattress	D/S	DOWNSTREAM	N.T.S	NOT TO SCALE
		Plain Cement Concrete	EL.	ELEVATION		
et		Reinforced Cement Concrete	F.B	FREE BOARD		
* * * * * * * * * * * * * * * * * * * *	_	Bank Protection	HFL	HIGH FLOOD LEVEL		
		Compacted Soil	HT.	HEIGHT		
\mathbb{Q}		Hill	H.G.L	HYDRAULIC GRADE LINE		
Mt W.II.		H.F.L / M.W.L	KM, km	KILOMETERE		
<u> 100.00</u>	-	Elevation of the point is (100m) in section veiw				
◆ 100,00		Elevation of the point (100m) in Plan view	M ,m	METRE		
ST-1		Traverse Station	Chkd Apprvd	CHECKED APPROVED		
B.M-1		Benchmark	M.W.L	MAXIMUM WATER LEVEL		
5.M-1			MIN	MINIMUM	0 SCALE 1:200 (A3)	500 1000 CENTEMETERS
[2233	1. 55 1	Lined Slope	No(s)	NUMBER(S)	SCALE 1:100 (A3)	00 300 400 500 CENTEMETERS
	(1 	Earthen Slope	N.G.L	NATURAL GROUND LEVEL	0 10 SCALE 1:10 (A3)	0 30 40 50 CENTEMETERS
	_	Ground Level	P.C.C	PLAIN CEMENT CONCRETE	0 SCALE 1:20 (A3) 0 50 1	CENTEMETERS
	2 <u> </u>	Stone Pitching/Rip Rap	R.C.C	REINFORCED CEMENT CONCRETE	SCALE 1:50 (A3)	CENTEMETERS

Notes:

- 1- All dimensions are in cm or as specified on drawing.
- 2- For concrete class and stone masonry type refer to Contract Specifications.
- 3- All cut-offs to be constructed against undisturbed soil.
- 4-Location of the structure, setting out and elevations to be confirmed by the WMD representative before construction.
- 5-The contractor shall construct and maintain all necessary
- channels, diviersion and other temporary works necessary to ensure that irrigation water supplies are not interrupted during construction works.
- 6-All elevations are based on local benchmark.
- 7-Coordinates and elevatoin of local bechmark are attached to every single site.
- 8-Contraction joint in concrete coping at wall top shall be provided at 1.0m centers 9.Contraction joint in concrete base slab shall be provided at 2m centers.
- 10-Minimum concrete cover to steel reinforcement shall be 50mm.
- 11-Steel reinforcement shall have a minimum yield stress of 250N/mm2.
- 12-For retaining wall more than 12m in length, expansion joint shall be provided at 12m centers.
- 13-Abbreviations used:
- GI stands for galvanized iron
- EW stands for each way
- EF stands for each face
- FB stands for free board
- Dia stands for diameter
- MS stands for mild steel

	Funded By	UNODC	Village Ghoryan	Survey by	Eng. Sayed Zaki Sadat	Tu	Sheet Index	Project Title	CheckDam
DACAAR / PROGRAM		ONOBC	District Nowzad	Drawn & Designed	by Eng. Sayed Zaki Sadat	Car -	Scale	Drawing Title	ABBREVIATION
	Implemented By			Reviewed By	Eng. Sayed Najib Jalal		Meter 02	0	
×-	Implemented by		Province Helmand	Checked & Approved	By Eng. Abdul Wali Muslih			Date:	Jan-2025

BRIEF TECHNICAL SPECIFICATIONS



CONCRETE WORKS:

- 1 All air entraining plain cement concrete should be M-200 by wright or be as specified on the drawings.
- 2 All PCC to have cement, sand and aggregate as specified on the drawings.
- 3 Concrete design should be based on a compressive strength of fc = 200kg/cm2 or as specified on the drawings.
- 4 Weight per unit volume of concrete W=2400kg/m3.
- 5- Sand or fine aggregate shall be free from salt, Alkali, Calcium sulphate or Vegetation and it shall not contain more than 0.5 percent by weight clay.
- 6 Aggregate:- Coarse aggregate shall consist of crushed gravel with the maximum size of 20mm.
- 7 The maximum slump for concrete should be between (5 7.5)cm. (For different concrete type refer to general specification).
- 8 To increase the workability of the concrete provide the chemical admixture (Super plasticizer, If required).
- 9 Water used for concrete mixture and concrete curing shall be from a source approved by the Engineer and at the time of use shall be free from contaminants.
- 10- Concrete compaction should be done by using concrete vibrator at the time of pouring in such a way to form a solid compact concrete.
- 11- Concrete curing should by continued for 28 days.
- 12- During cold weather concreting should be stopped or the contractor has to consider cold weather concreting procedure as accepted by the Engineer. (Or refer to general specification).
- 13- Concrete shuttering / formwork should be of steel or wooden type.
- 14- Concrete shuttering can be removed as per below minimum duration: Side of beams, Walls, Columns (16 24 Hours).
 Forms from beneath the slabs (Spaning up to 6m.) 14 Days.
 Forms from beneath the slabs (Spaning above 6m.) 21 Days
- 15- All air entrained concrete with 4.5% 7% of air volumes should be used instead of normal concrete works by adding approved admixture.
- 16- All RCC should be M-25.
- 17- All blinding PCC shall be M-10.
- 18- Reinforcement yield strength fy shall not be less that (2500kg/cm2).

MASONRY WORKS:

- 1 Plum / Mass air entraining concrete shall contain a maximum of 40% stone with a maximum stone size as 20cm.
 The concrete ratio shall be M-20.
- 2 Stone for Stone masonry, Gabion and grouted stone pitching should be of good quality and approved by Engineer.
- 3 All stone masonry for foundations should be with ratio of (1:3).
- 4 All masonry cutoff wall shall be with (1:3) Cement sand mortar or as specified on the drawing.

EARTH WORKS:

- 1 Backfilling material should be properly tested and selected to be suitable as per standard practice.
- 2 For backfilling maximum thickness of each loose soil layer should not more than 15cm. According to general specification.
- 3 Standard compaction tests should be carried out for the backfilling.
- 4 The percentage of compaction should be not less than (92 95)% of the maximum dry density of selected material by the Engineer.


GABION WORKS:

- 1 Stone size for gabion shall range from (20 30cm) dia. According to general specification.
- 2 Galvinized iron wier of specified thickness (2.7-3.0)mm Should be properly woven and knotted together to form the required mesh in hexagonal / rectangular shape of size (8 10cm) for gabion basket and (10 12cm) for gabion mattress to fabricate gabion boxes to the saftsfaction of the Engineer.
- 3 Principal wire along the gabion edges (Selvedges) for gabion boxes should be of galvanized iron having minimum thickness of (4mm).
- 4 Gabion galvanized iron wire tensile strength should be (350 575 N / mm2).


OTHERS:

- 1 Bitumen coating should be used in all contraction / Expansion joints.
- 2 All quality control field tests should be carried out by the contractor in a specified laboratory as accepted by the client.
- 3 Construction joints for PCC and masonry walls should be provided as (15 20m) center to center.
- 4- All diversions and flood protection works is contractor responsibility,

	Funded By	UNODC	Village Ghoryan	Survey by	Eng. Sayed Zaki Sadat	Tole	Sheet Index	Project Title	CheckDam
DACAAR / PROGRAM			District Nowzad	Reviewed Ry	Eng. Sayed Zaki Sadat Eng. Sayed Najib Jalal		Scale Meter 03	Drawing Title	BRIEF TECHNICAL SPECIFICATIONS
-	Implemented By		Province Helmand	Checked & Approved B	Eng. Abdul Wali Muslih		10	Date :	Jan-2025

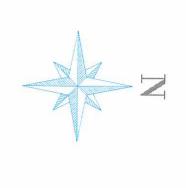



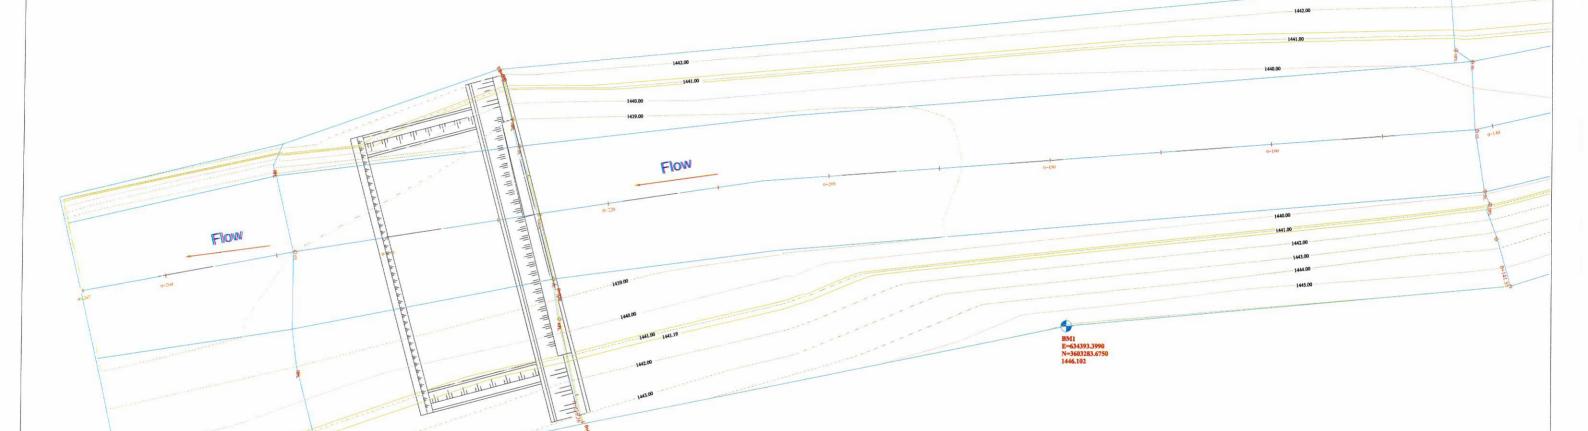


Topo Plan of Check Dam

Bench Mark
SPRING
Canal
Bed


LEGEND

Benchmark Table								
Point #	Elevation	Northing	Easting	Description				
1	1446.10	3603283.68	634393.40	ВМ				

	Funded By	UNODC	Village Ghoryan	Survey by	Eng. Sayed Zaki Sadat	Jul	Sheet Index	Project Title	CheckDam
DACAAR / PROGRAM		-	- District Nowzad	Drawn & Designed Reviewed By	by Eng. Sayed Zaki Sadat Eng. Sayed Najib Jalal		Scale Meter 04	Drawing Title	Topo Plan Of Check Dam
*	Implemented By		Province Helmand	Checked & Approved	By Eng. Abdul Wali Muslih		10	Date :	Jan-2025

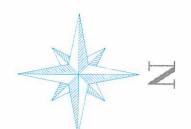



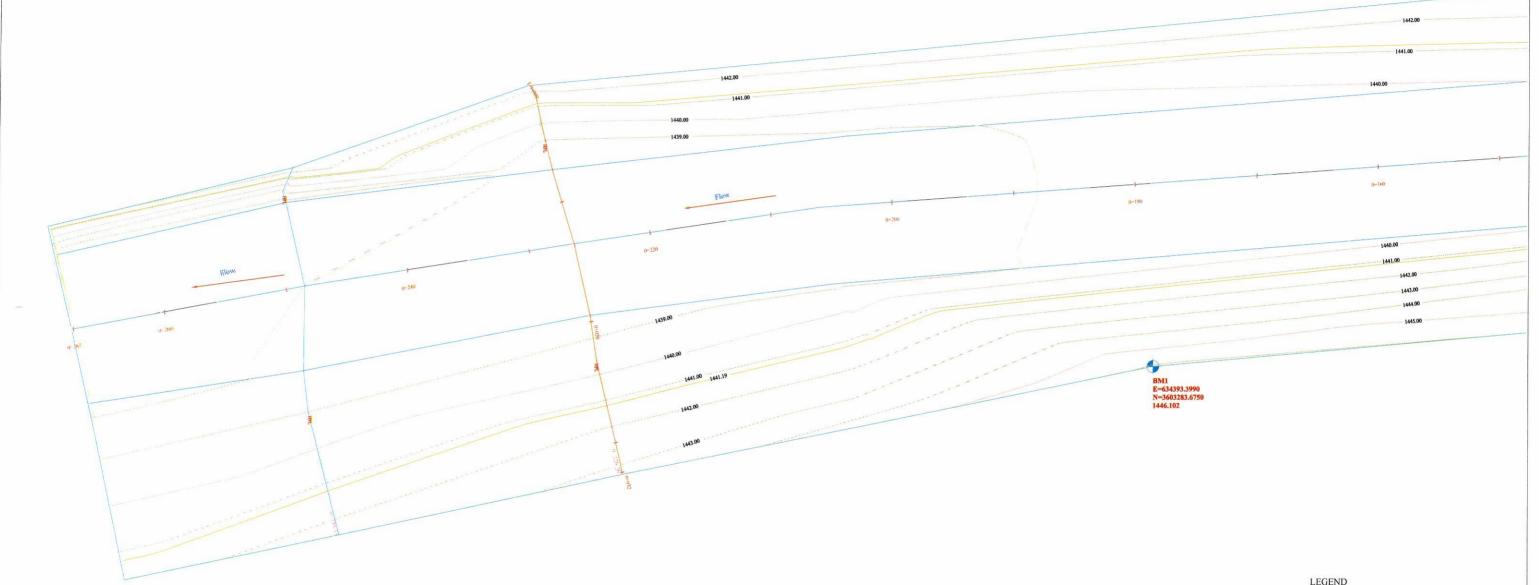

Site Plan of Check Dam


1	Bench Mark	
	SPRING	
	Canal	
	Bed	
As per	Site	

		10/10/2019/19/19		
Point #	Elevation	Northing	Easting	Description
1	1446.10	3603283.68	634393.40	BM

	Funded By	UNODC	Village Ghoryan	Survey by	Eng. Sayed Zaki Sadat	7w	Sheet Index	Project Title	CheckDam
DACAAR / PROGRAM	-		- District Nowzad	Drawn & Designed b	Eng. Sayed Zaki Sadat Eng. Sayed Najib Jalal		Scale Meter 05	Drawing Title	Site Plan Of Check Dam
4	Implemented By		Province Helmand	Checked & Approved B	y Eng. Abdul Wali Muslih		10	Date :	Jan-2025



Plan Of Check Dam

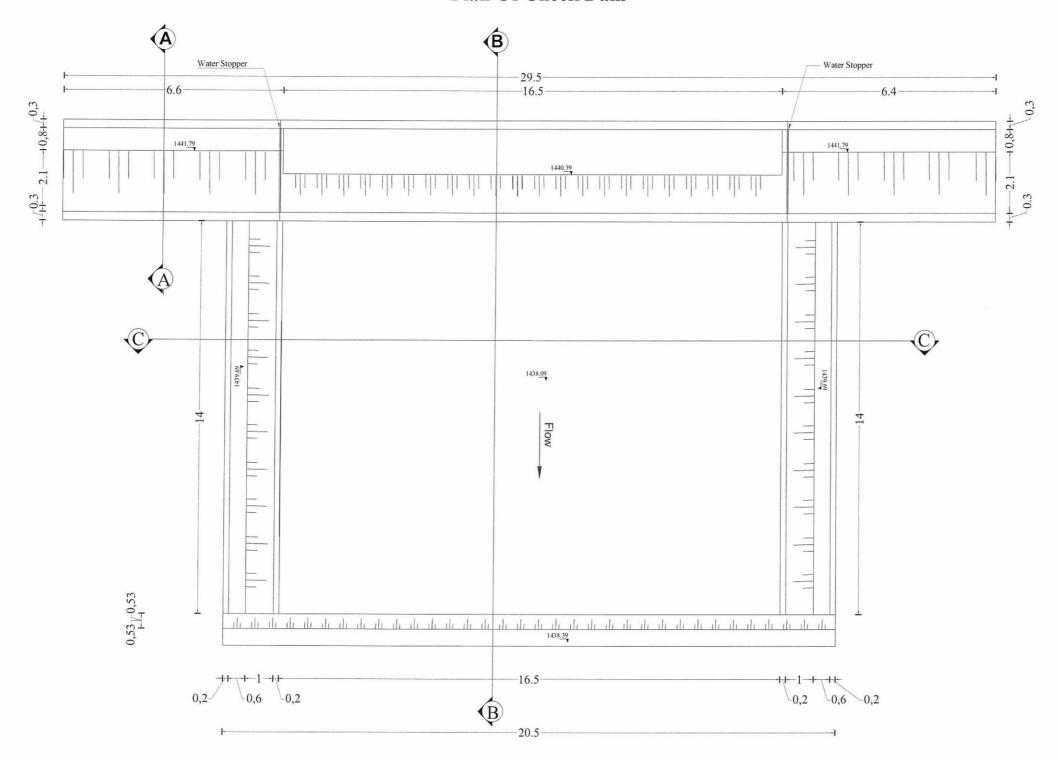


Note:

- All dimensions are in M.
- All Excavated material can be use it upstream and downstream faces fillings with 90% Compaction.
- Filling layers must not be Pave more than (15-20)cm thickness.

D. A. O. A. D. A. D. D. O. D. A. A.	Funded By	UNODC	Village Ghoryan	Survey by	Eng. Sayed Zaki Sadat	- Pour	Sheet Index	Project Title	CheckDam
DACAAR / PROGRAM		+	District Nowzad	Drawn & Designed by Reviewed By	Eng. Sayed Zaki Sadat Eng. Sayed Najib Jalal		Scale Meter 06	Drawing Title	Plan Of Check Dam
	Implemented By	SF4	Province Helmand	Checked & Approved By	y Eng. Abdul Wali Muslih		10	Date :	Jan-2025



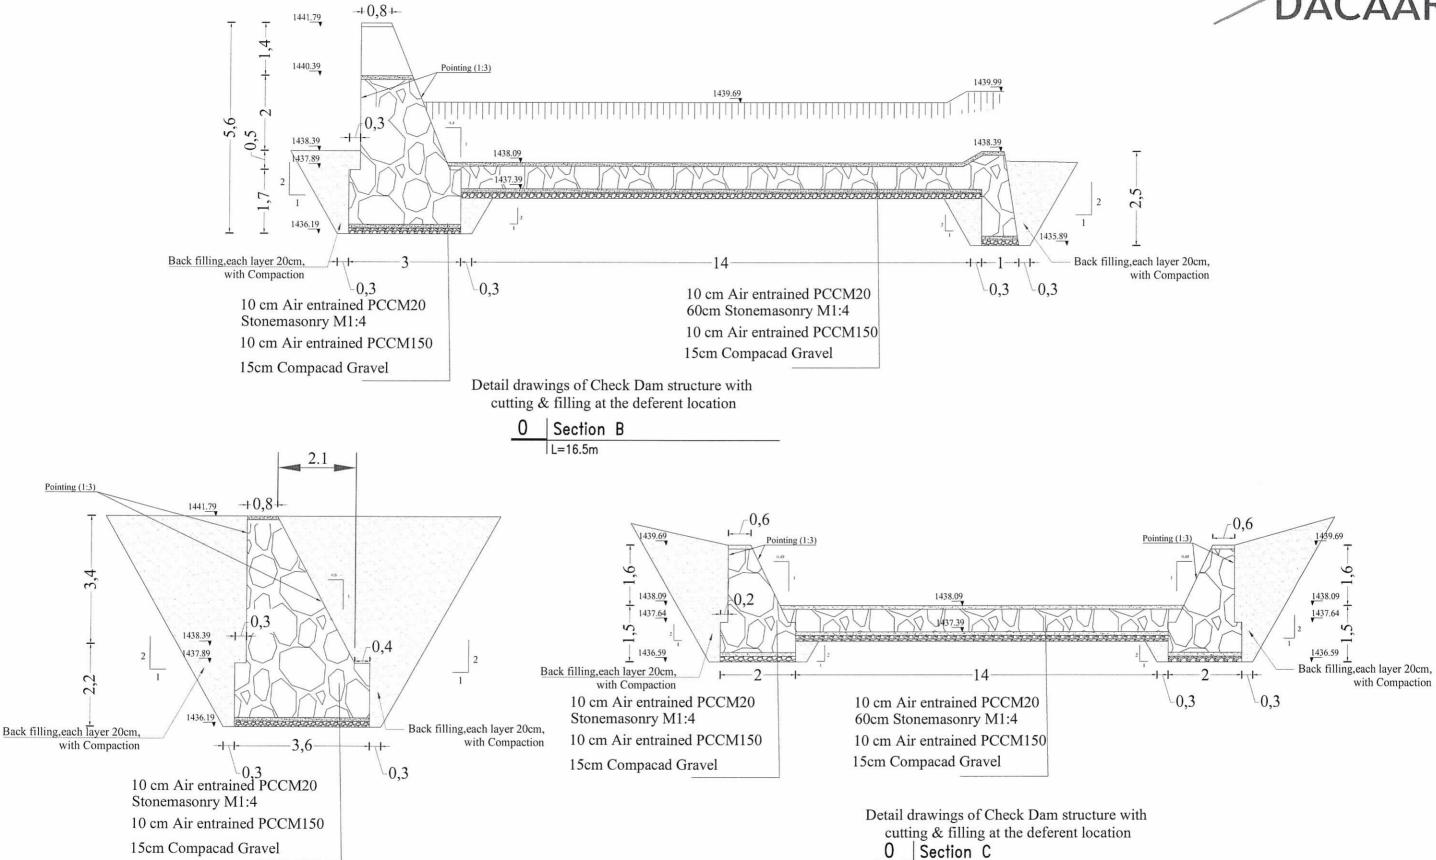

Pointing (1:3)


2,2


Detail drawings of Check Dam structure with cutting & filling at the deferent location

4	Funded By	UNODC	Village Ghoryan	Survey by	Eng. Sayed Zaki Sadat	- Tai		Sheet Index	Project Title	CheckDam
DACAAR / PROGRAM			District Nowzad	Drawn & Designed by	Eng. Sayed Zaki Sadat Eng. Sayed Najib Jalal		Scale Meter	07	Drawing Title	Detail drawings
	Implemented By		Province Helmand	Checked & Approved B	By Eng. Abdul Wali Muslih			10	Date :	Jan-2025

L=14m



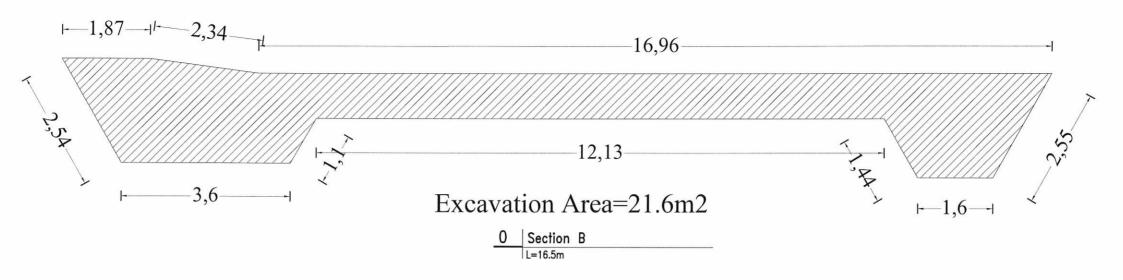


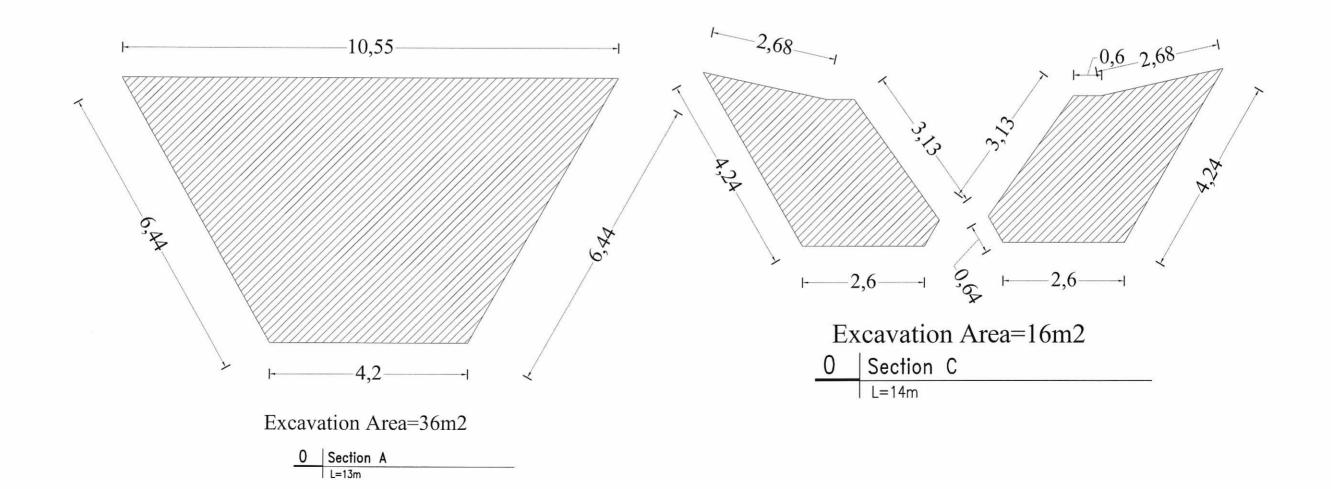

	Funded By	UNODC	Village Ghoryan	Survey by	Eng. Sayed Zaki Sadat	- Tui	Sheet Index	Project Title	CheckDam
DACAAR / PROGRAM	1		District Nowzad	Drawn & Designed Reviewed By	d by Eng. Sayed Zaki Sadat Eng. Sayed Najib Jalal		Scale Meter 08	Drawing Title	Cutting Section
	Implemented By		Province Helmand	Checked & Approved	By Eng. Abdul Wali Muslih		10	Date :	Jan-2025






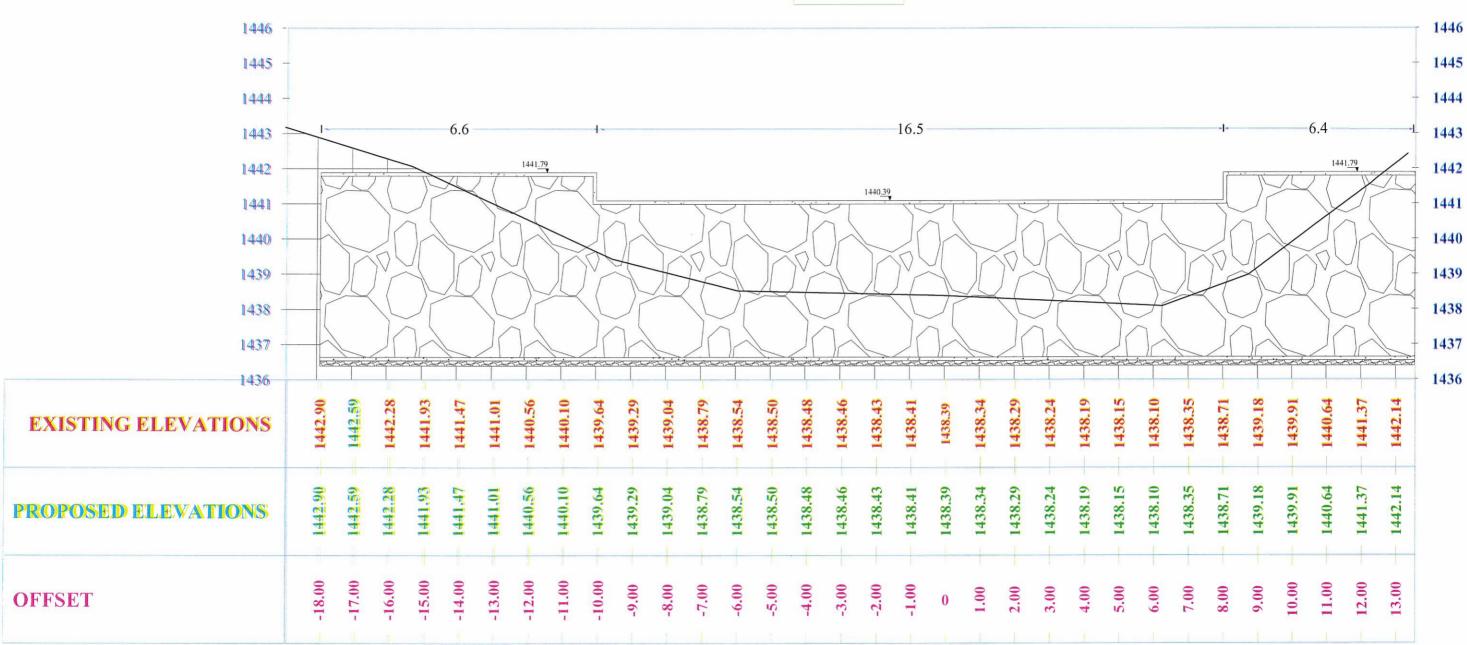

GHORYAN CHECK DAM ON RIVER X- SECTION AT CH:0+226.26

	Funded By	UNODC	Village Ghoryan	Survey by Drawn & Designed b	Eng. Sayed Zaki Sadat	7m	Scale Sheet Index	Project Title Drawing Title	CheckDam
DACAAR / PROGRAM	Implemented By		Province Helmand	Reviewed By Checked & Approved B	Eng. Sayed Najib Jalal y Eng. Abdul Wali Muslih		Meter 09 10	Date :	RIVER X- SECTION Jan-2025



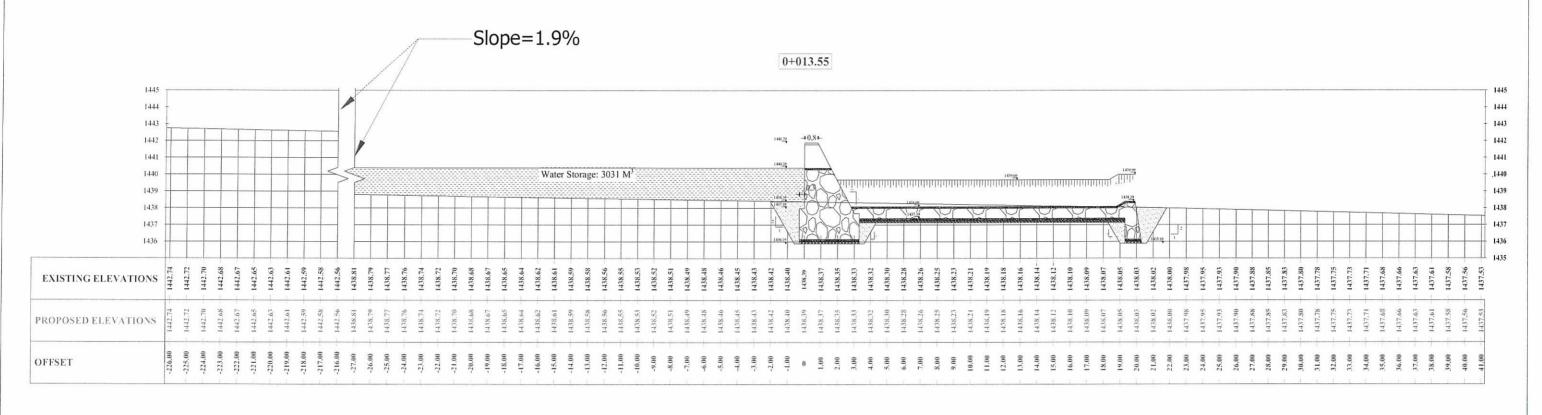

GHORYAN CHECK DAM ON RIVER L- SECTION AT CH:0+013.55

	Funded By	UNODC	Village Ghoryan	Survey by Eng. Sayed Zaki Sadat	Tue Sheet I	ndex Project Title	CheckDam
DACAAR / PROGRAM			District Nowzad	Drawn & Designed by Eng. Sayed Zaki Sadat Reviewed By Eng. Sayed Najib Jalal	Scale Meter 10	Drawing Title	RIVER L- SECTION
	Implemented By		Province Helmand	Checked & Approved By Eng. Abdul Wali Muslih	10	Date :	Jan-2025